



JOB No.	MASTER
DATE DRAWN	7/16/2019
DATE PRINTED	2/7/2021

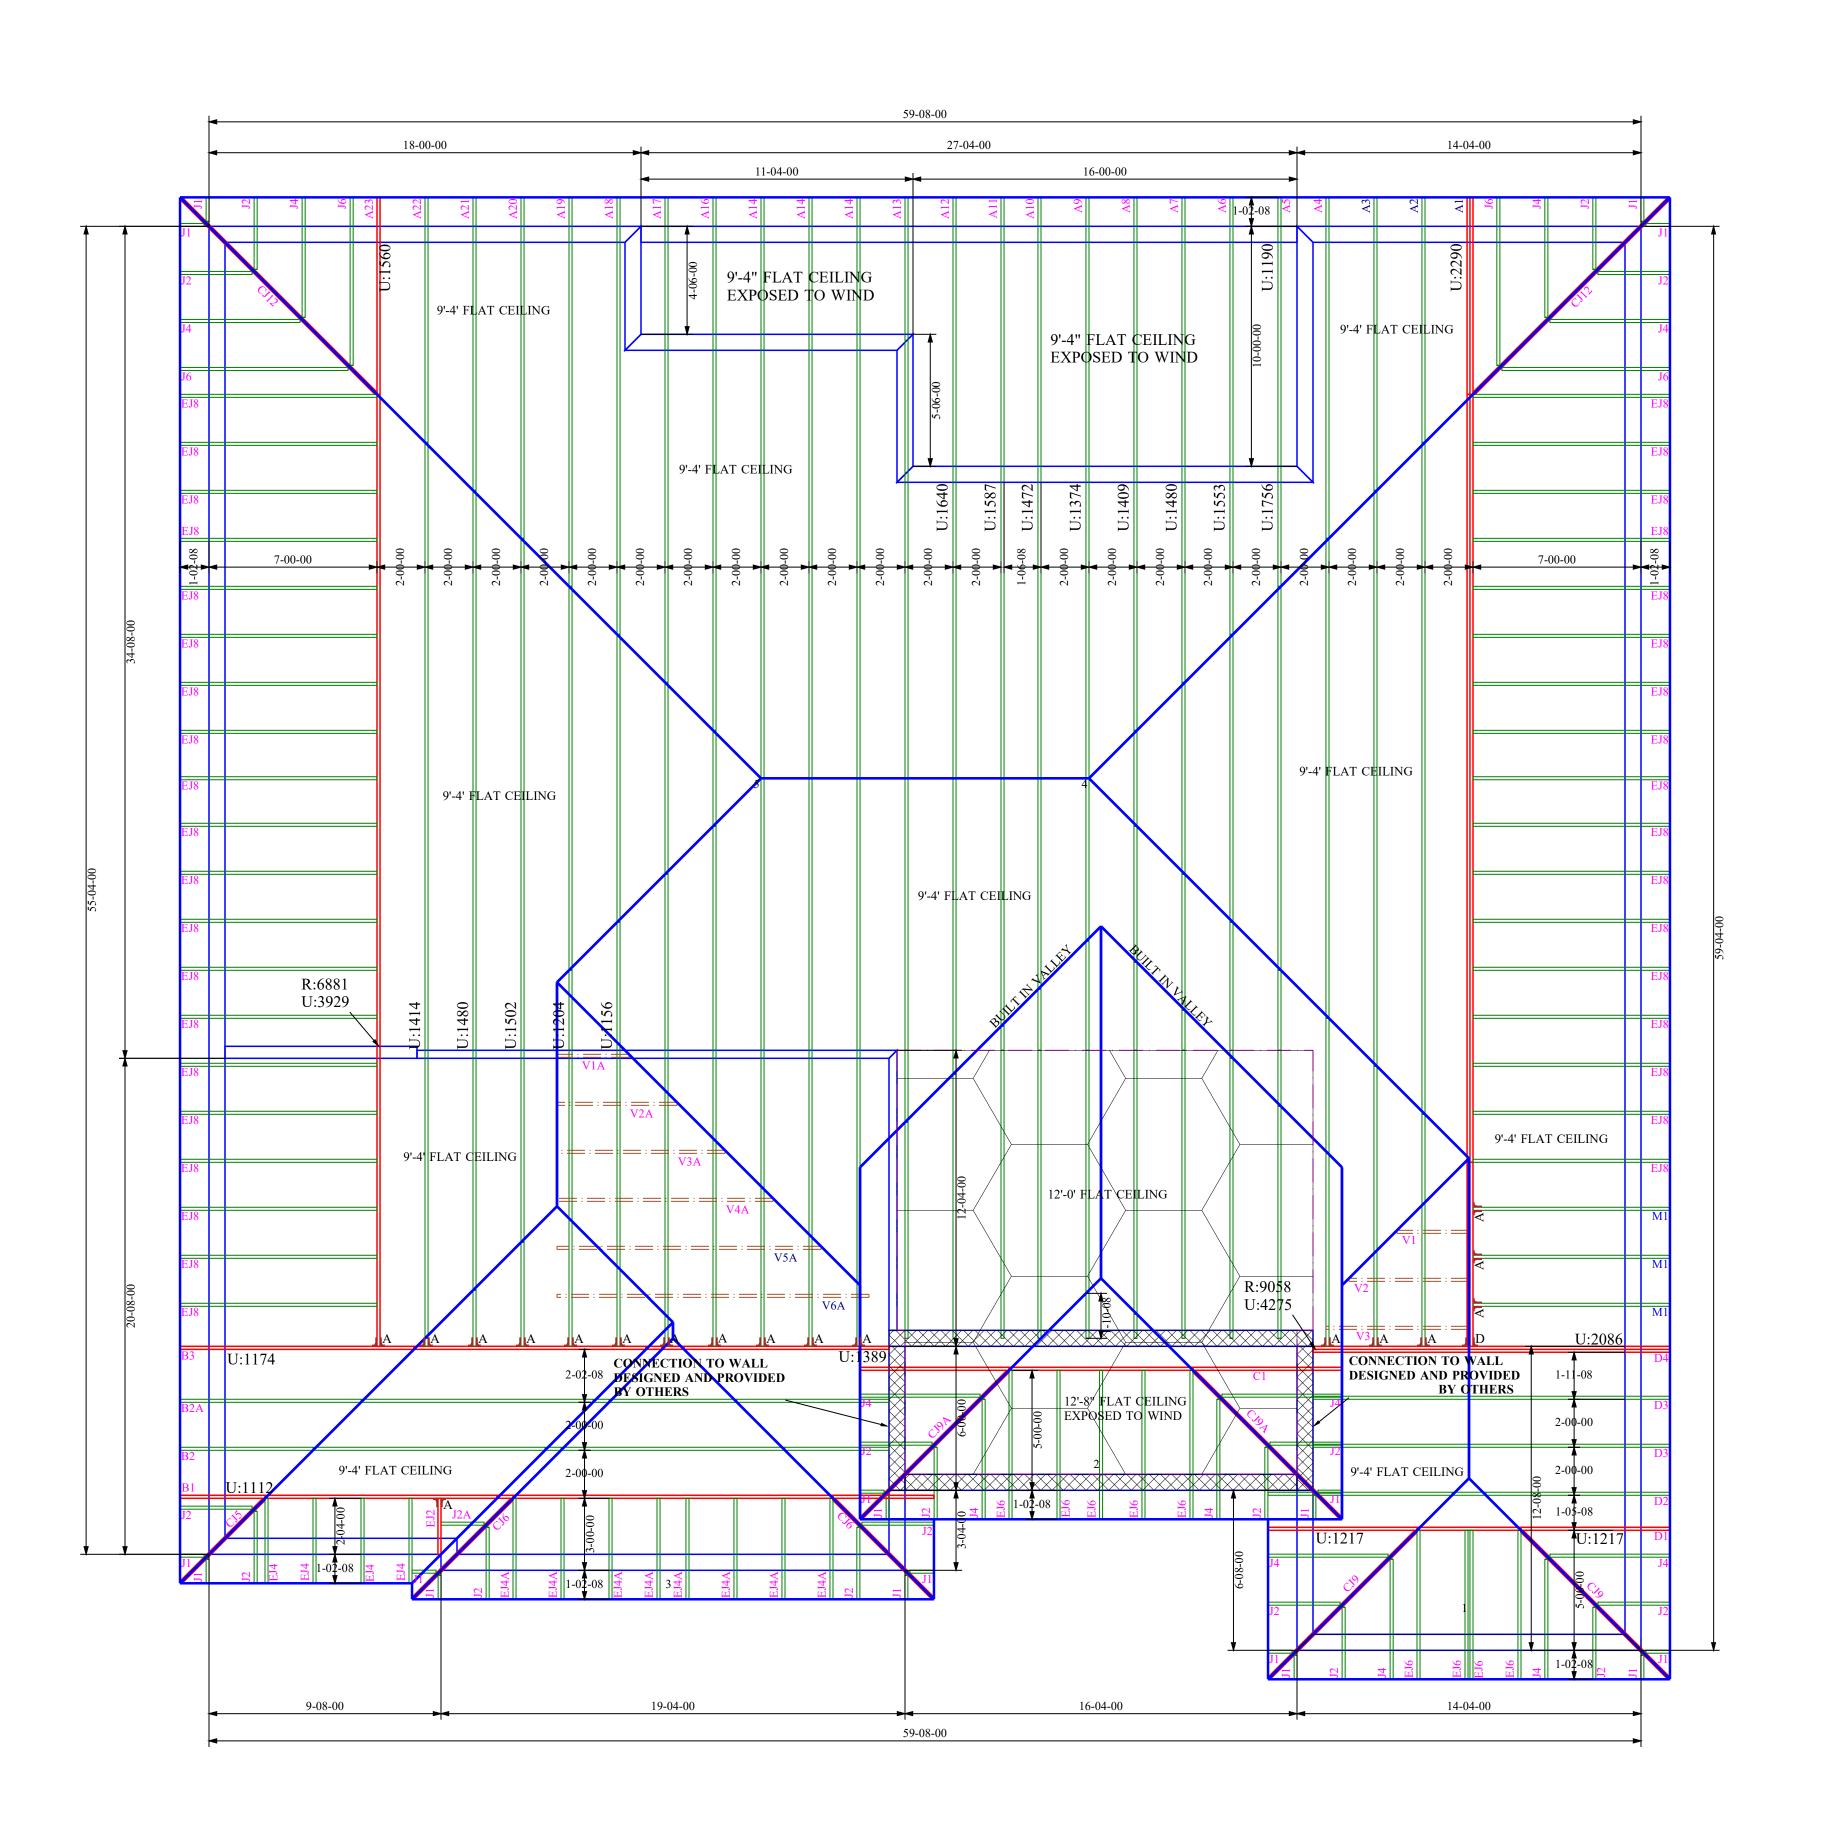

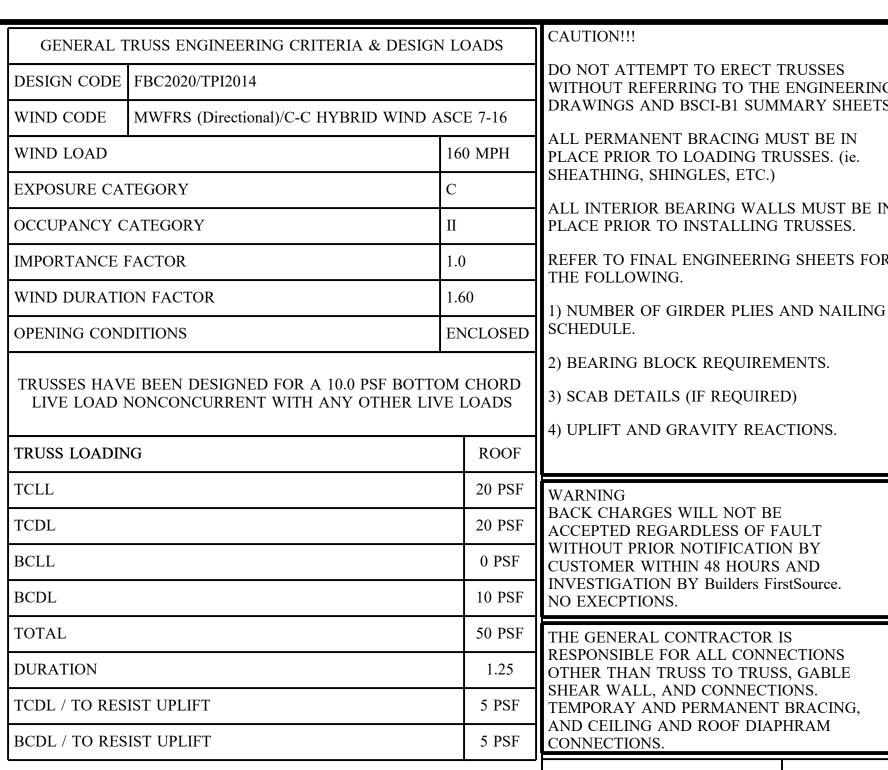

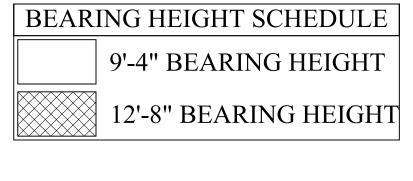

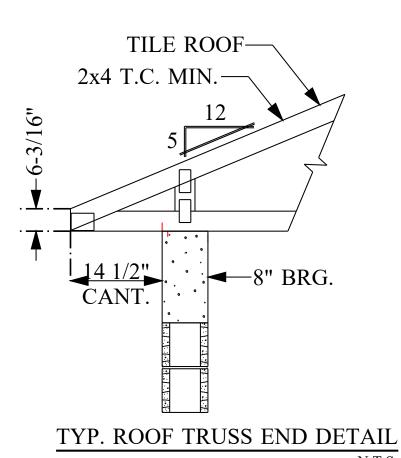

# SIMPSON CONNECTOR SCHEDULE

	ROOF TRUSS					FLOOR TRUSS							
QTY	ID	MODEL	ROOF	UPL	.IFT	SYMBOL	QTY	ID	MODEL	FLOOF	<b>ર</b>	JPLIFT	SYMBOL
0	A*	LUS24	895	490		ĭr <sub>∀∗</sub>	0	A*	LUS24	895		490	1r <sub>∀∗</sub>
							0	Α	HTU26	3200 / 36	000	1250 / 1555	1r <sub>V</sub>
0	Α	HTU26	3200 / 360	00 1250	/ 1555	ΊΓ	0	В	HTU28	3895 / 46	80	1235 / 2140	ΊΓΒ
0	В	HTU28	3895 / 468	30 1235	/ 2140	1fB	0	С	HTU26-2	3600		1515 / 2175	110
0	С	HTU26-2	3600	1515	/ 2175	] [c	0	D	HTU28-2	4310 / 46	80	1530 / 3485	J ID
0	D	HTU28-2	4310 / 468	30 1530	/ 3485	J ID	0	Е	HGUS26-2	5320		2155	J (E
0	Е	HGUS26-2	5320	2155	j	J (E	0	F	HGUS28-2	7460		3235	JF
0	F	HGUS28-2	7460	3235	j	J (F	0	G	HGUS26-3	5230		2155	1 fe
0	G	HGUS26-3	5230	2155	j	J [G	0	Н	HGUS28-3	7460		3235	J 1H
0	Н	HGUS28-3	7460	3235	j	J IH	0	J	HGUS210-4	9100	.	4095	1 m
0	J	HGUS210-4	9100	4095	j	ΙU	0	L	HHUS46	2790		1550	111
	K	SPECIAL					0	М	THA422	1415 / 22	245	N/A	1 IM
		A	CCESS	ORIE	S		0	N	THAC422	1415 / 22	245	N/A	1 M
	3x8	NAIL ON PLA	TES				0	0	THA426	2435 / 22	245	N/A	1 fo
	SE	AT PLATES					ACCESSORIES						
<u>'</u>	•	SCREWS			BOLTS	 S		3x8	NAIL ON PLA	TES			
QTY		MODEL	ľ	ΩTY	MODE	<u> </u>		SE	AT PLATES				
<u> </u>		SDS 1/4" x 3"				ARR. BOLTS			SCREWS			BOLT	3
		SDS 1/4 x 3-			" WASH		QTY		MODEL		QTY	MODE	L
		SDS 1/4" x 6"			" NUTS				SDS 1/4" x 3"	,		1/2" x 8" C/	ARR. BOLTS
A [:]	[ii] ⊢			. 1		HUS46			SDS 1/4" x 4-			1/2" WASH	
1::	' الأ	ITU26 C [ PLY TYP.	2 PLY			LOOR TYP.			SDS 1/4" x 6"			1/2" NUTS	

	MISCELLANEOUS							
	ROOF TRUSS		FLOOR TRUSS					
QTY	MODEL	QTY	MODEL					

- 1) ALL DIMENSIONS ARE FEET-INCHES-SIXTEENTHS.
- 2) DO NOT CUT OR ALTER TRUSSES IN ANY WAY.
- 3) ALL REACTIONS ARE UNDER 5000 LBS. UNLESS NOTE OTHERWISE. 4) ALL UPLIFTS ARE UNDER 1000 LBS. UNLESS NOTED OTHERWISE.
- 5) FRAMING REQUIRED BELOW TRUSSES TO GET DESIRED CEILING CONDITIONS. 6) ONLY TRUSS TO TRUSS CONNECTIONS SUPPLIED W/ TRUSS PACKAGE.

CAUTION!!!

DO NOT ATTEMPT TO ERECT TRUSSES WITHOUT REFERRING TO THE ENGINEERING DRAWINGS AND BSCI-B1 SUMMARY SHEETS.

ALL PERMANENT BRACING MUST BE IN PLACE PRIOR TO LOADING TRUSSES. (ie. SHEATHING, SHINGLES, ETC.)

ALL INTERIOR BEARING WALLS MUST BE IN PLACE PRIOR TO INSTALLING TRUSSES.

REFER TO FINAL ENGINEERING SHEETS FOR THE FOLLOWING.

2) BEARING BLOCK REQUIREMENTS.

3) SCAB DETAILS (IF REQUIRED)

4) UPLIFT AND GRAVITY REACTIONS.

WARNING BACK CHARGES WILL NOT BE ACCEPTED REGARDLESS OF FAULT WITHOUT PRIOR NOTIFICATION BY CUSTOMER WITHIN 48 HOURS AND INVESTIGATION BY Builders FirstSource. NO EXECPTIONS.

THE GENERAL CONTRACTOR IS RESPONSIBLE FOR ALL CONNECTIONS OTHER THAN TRUSS TO TRUSS, GABLE SHEAR WALL, AND CONNECTIONS. TEMPORAY AND PERMANENT BRACING, AND CEILING AND ROOF DIAPHRAM CONNECTIONS.

ROOF PITCH	5/12
CEILING PITCH	FLAT
TOP CHORD SIZE	2 x 4 MIN.
BOTTOM CHORD SIZE	2 x 4 MIN.
OVERHANG LENGTH	N/A
CANTILEVER	14 1/2"
END CUT	PLUMB
FLOOR TRUSS SPACING	N/A
ROOF TRUSS SPACING	24"

BUILDER	DR Horton
PROJECT	2414 B 160 C LH
MODEL	2414
ADDRESS	
CITY, STATE	, FL.
LOT	
COUNTY	
DRAWN BY	D.W.
FNG BY	D W

**REVISIONS** 

No.	DATE	NOTES	ВУ
1 2	/7/2021 Chan	ged code to FBC2020/TPI2014	D.V


### **IMPORTANT**

This Drawing Must Be Approved And Returned Before Fabrication Will Begin. For Your Protection Check All Dimensions And Conditions Prior To


Approval Of Plan. SIGNATURE BELOW INDICATES ALL NOTES AND DIMENSIONS HAVE BEEN ACCEPTED.


6850 Taylor Road Punta Gorda, Fl. 33950 Phone: 941-575-2250 / Fax:941-575-0319




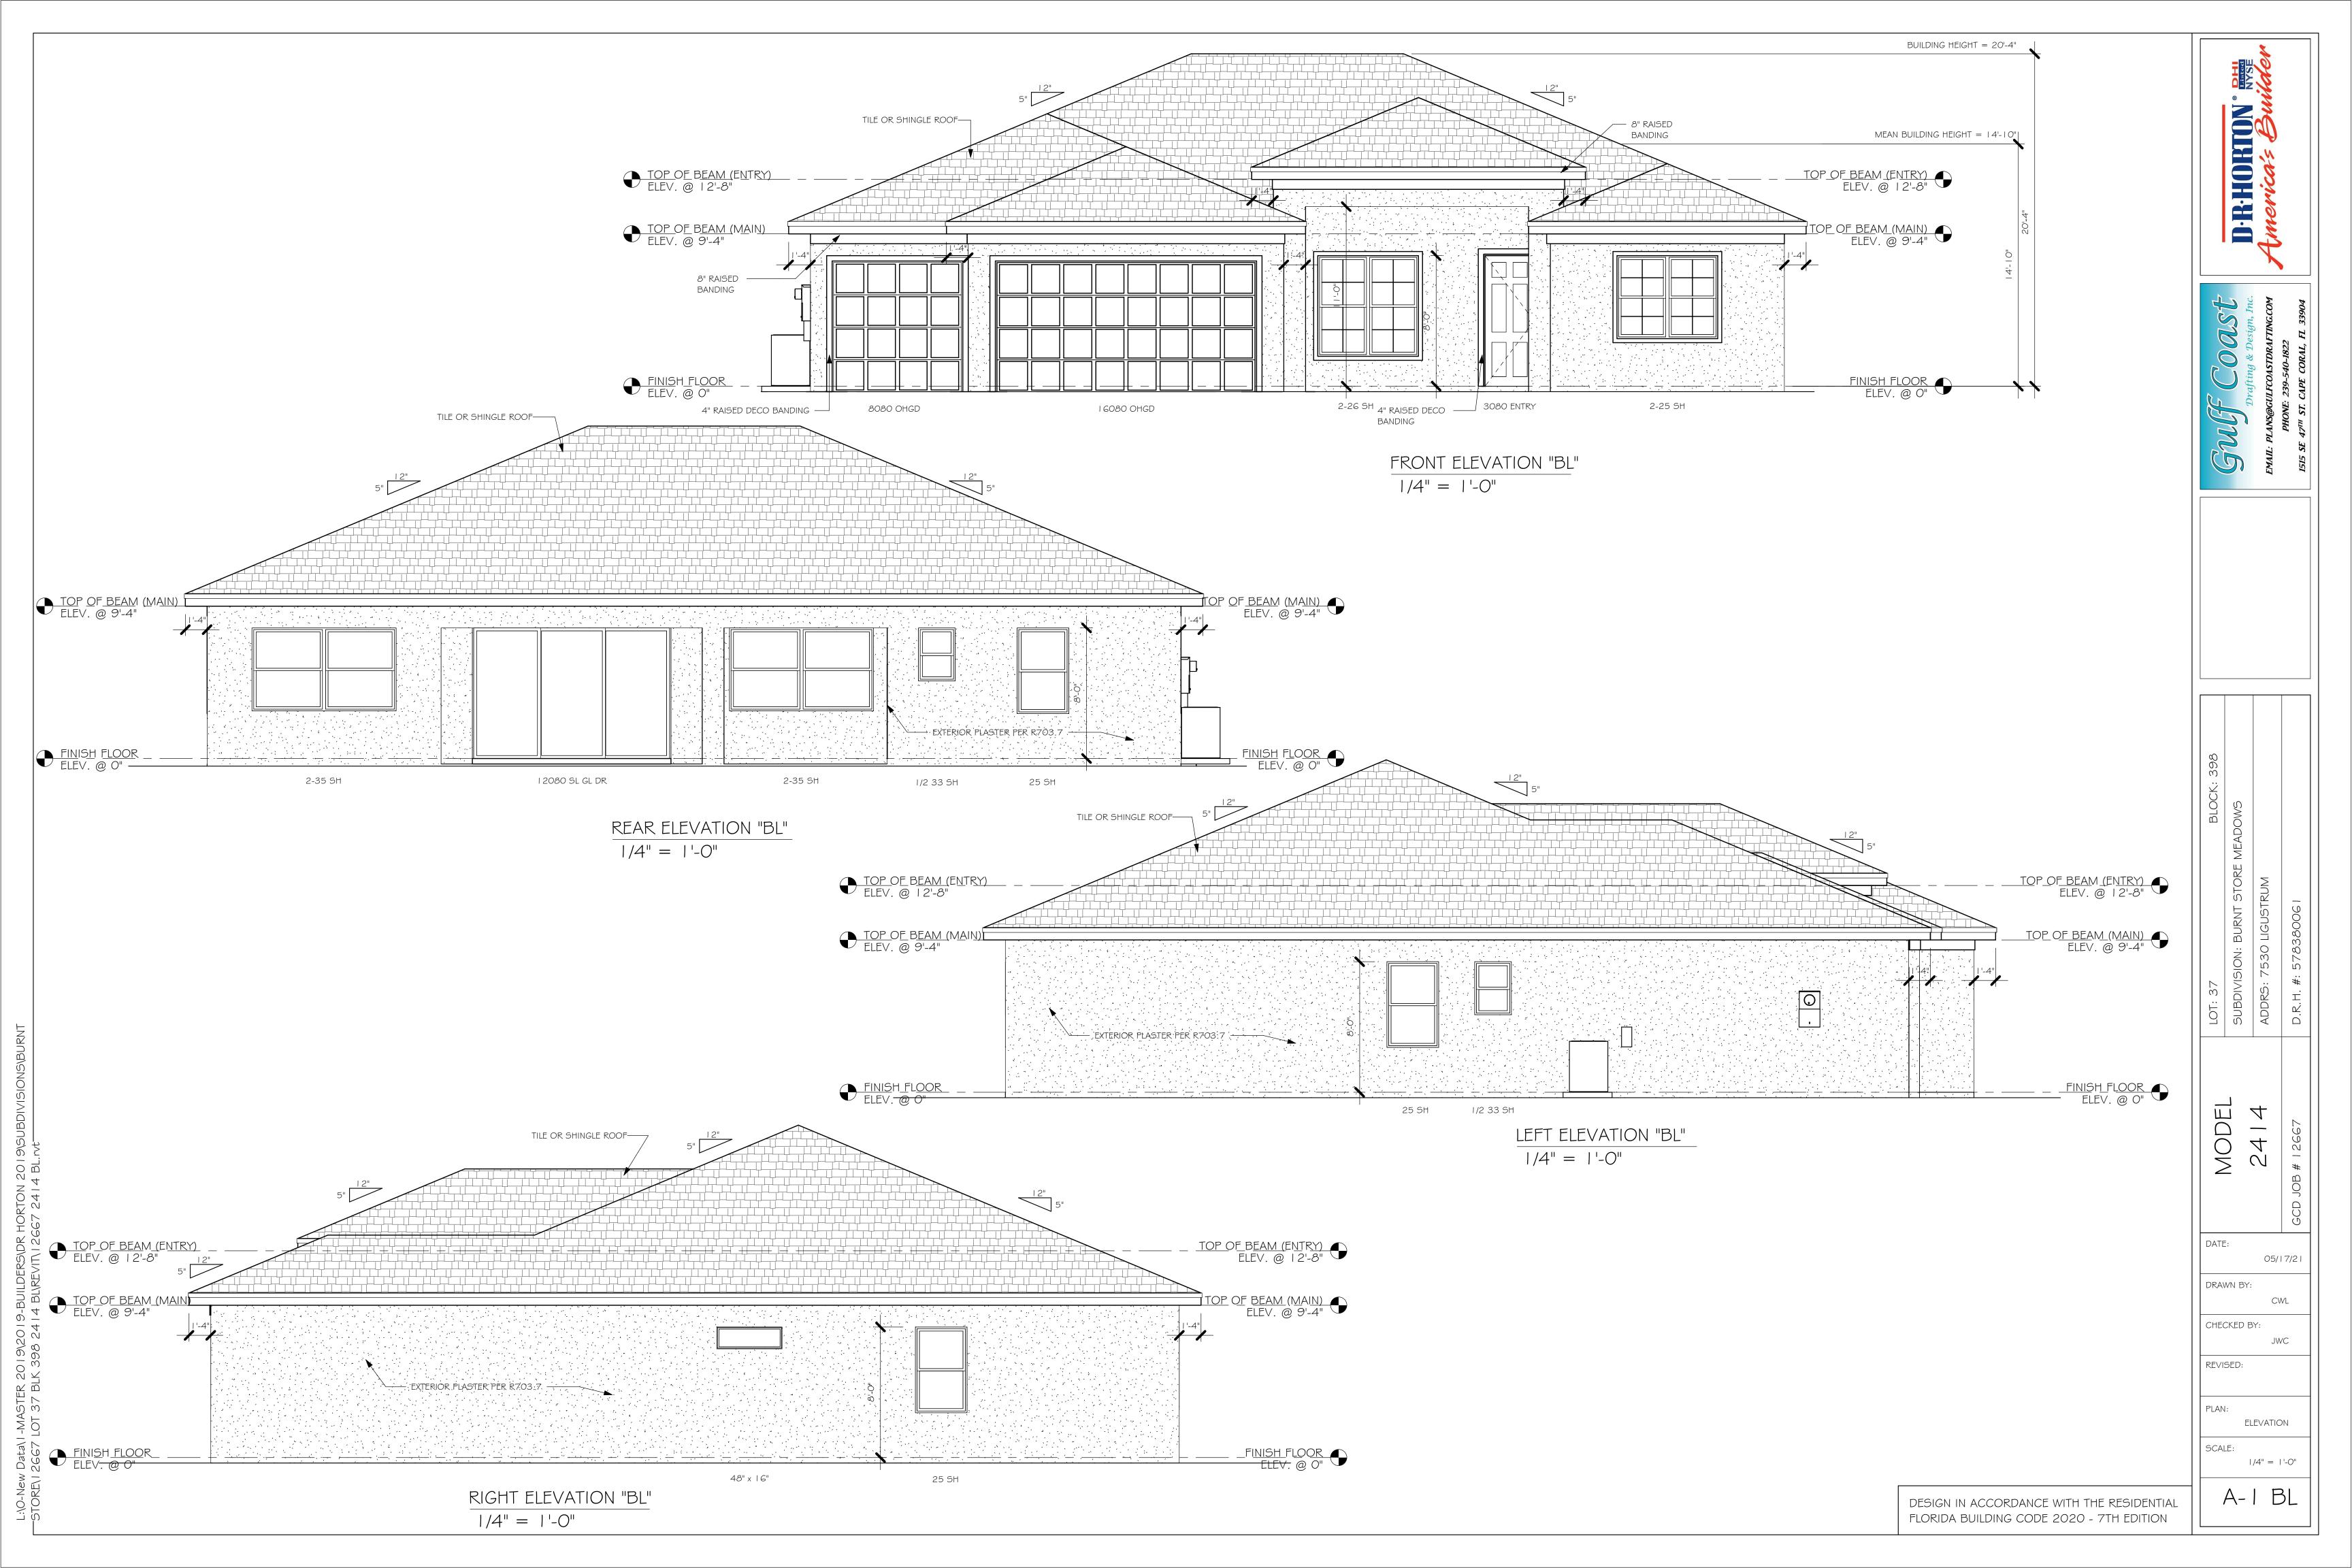




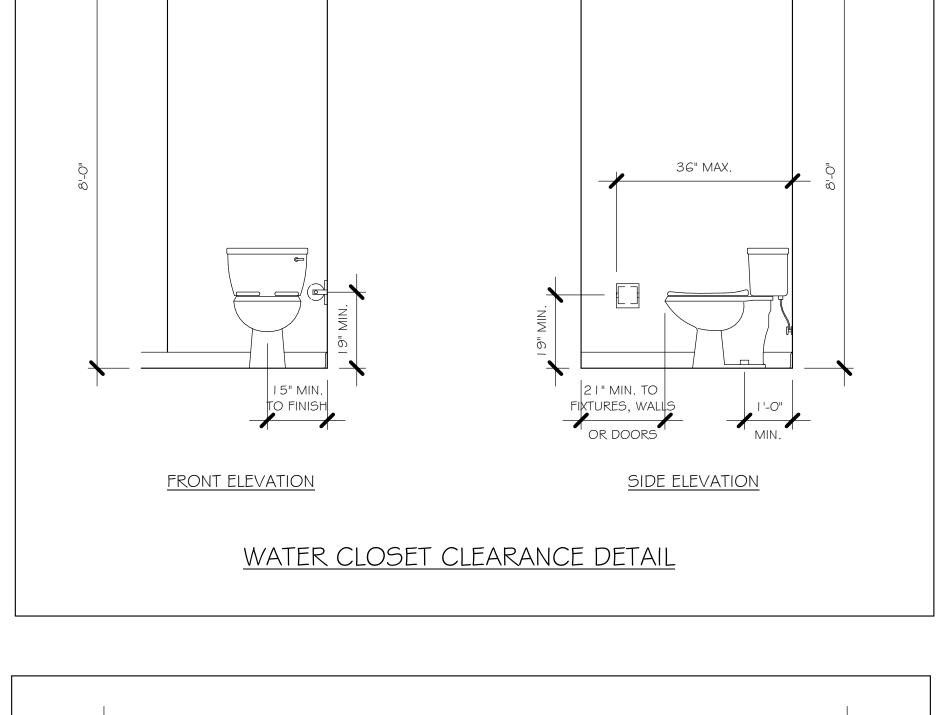

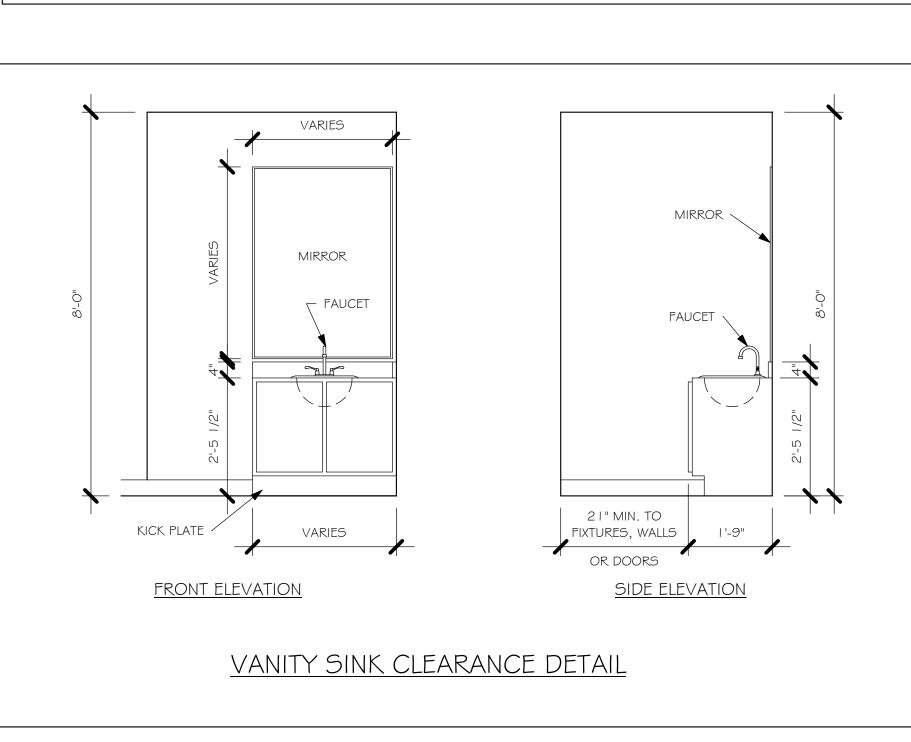

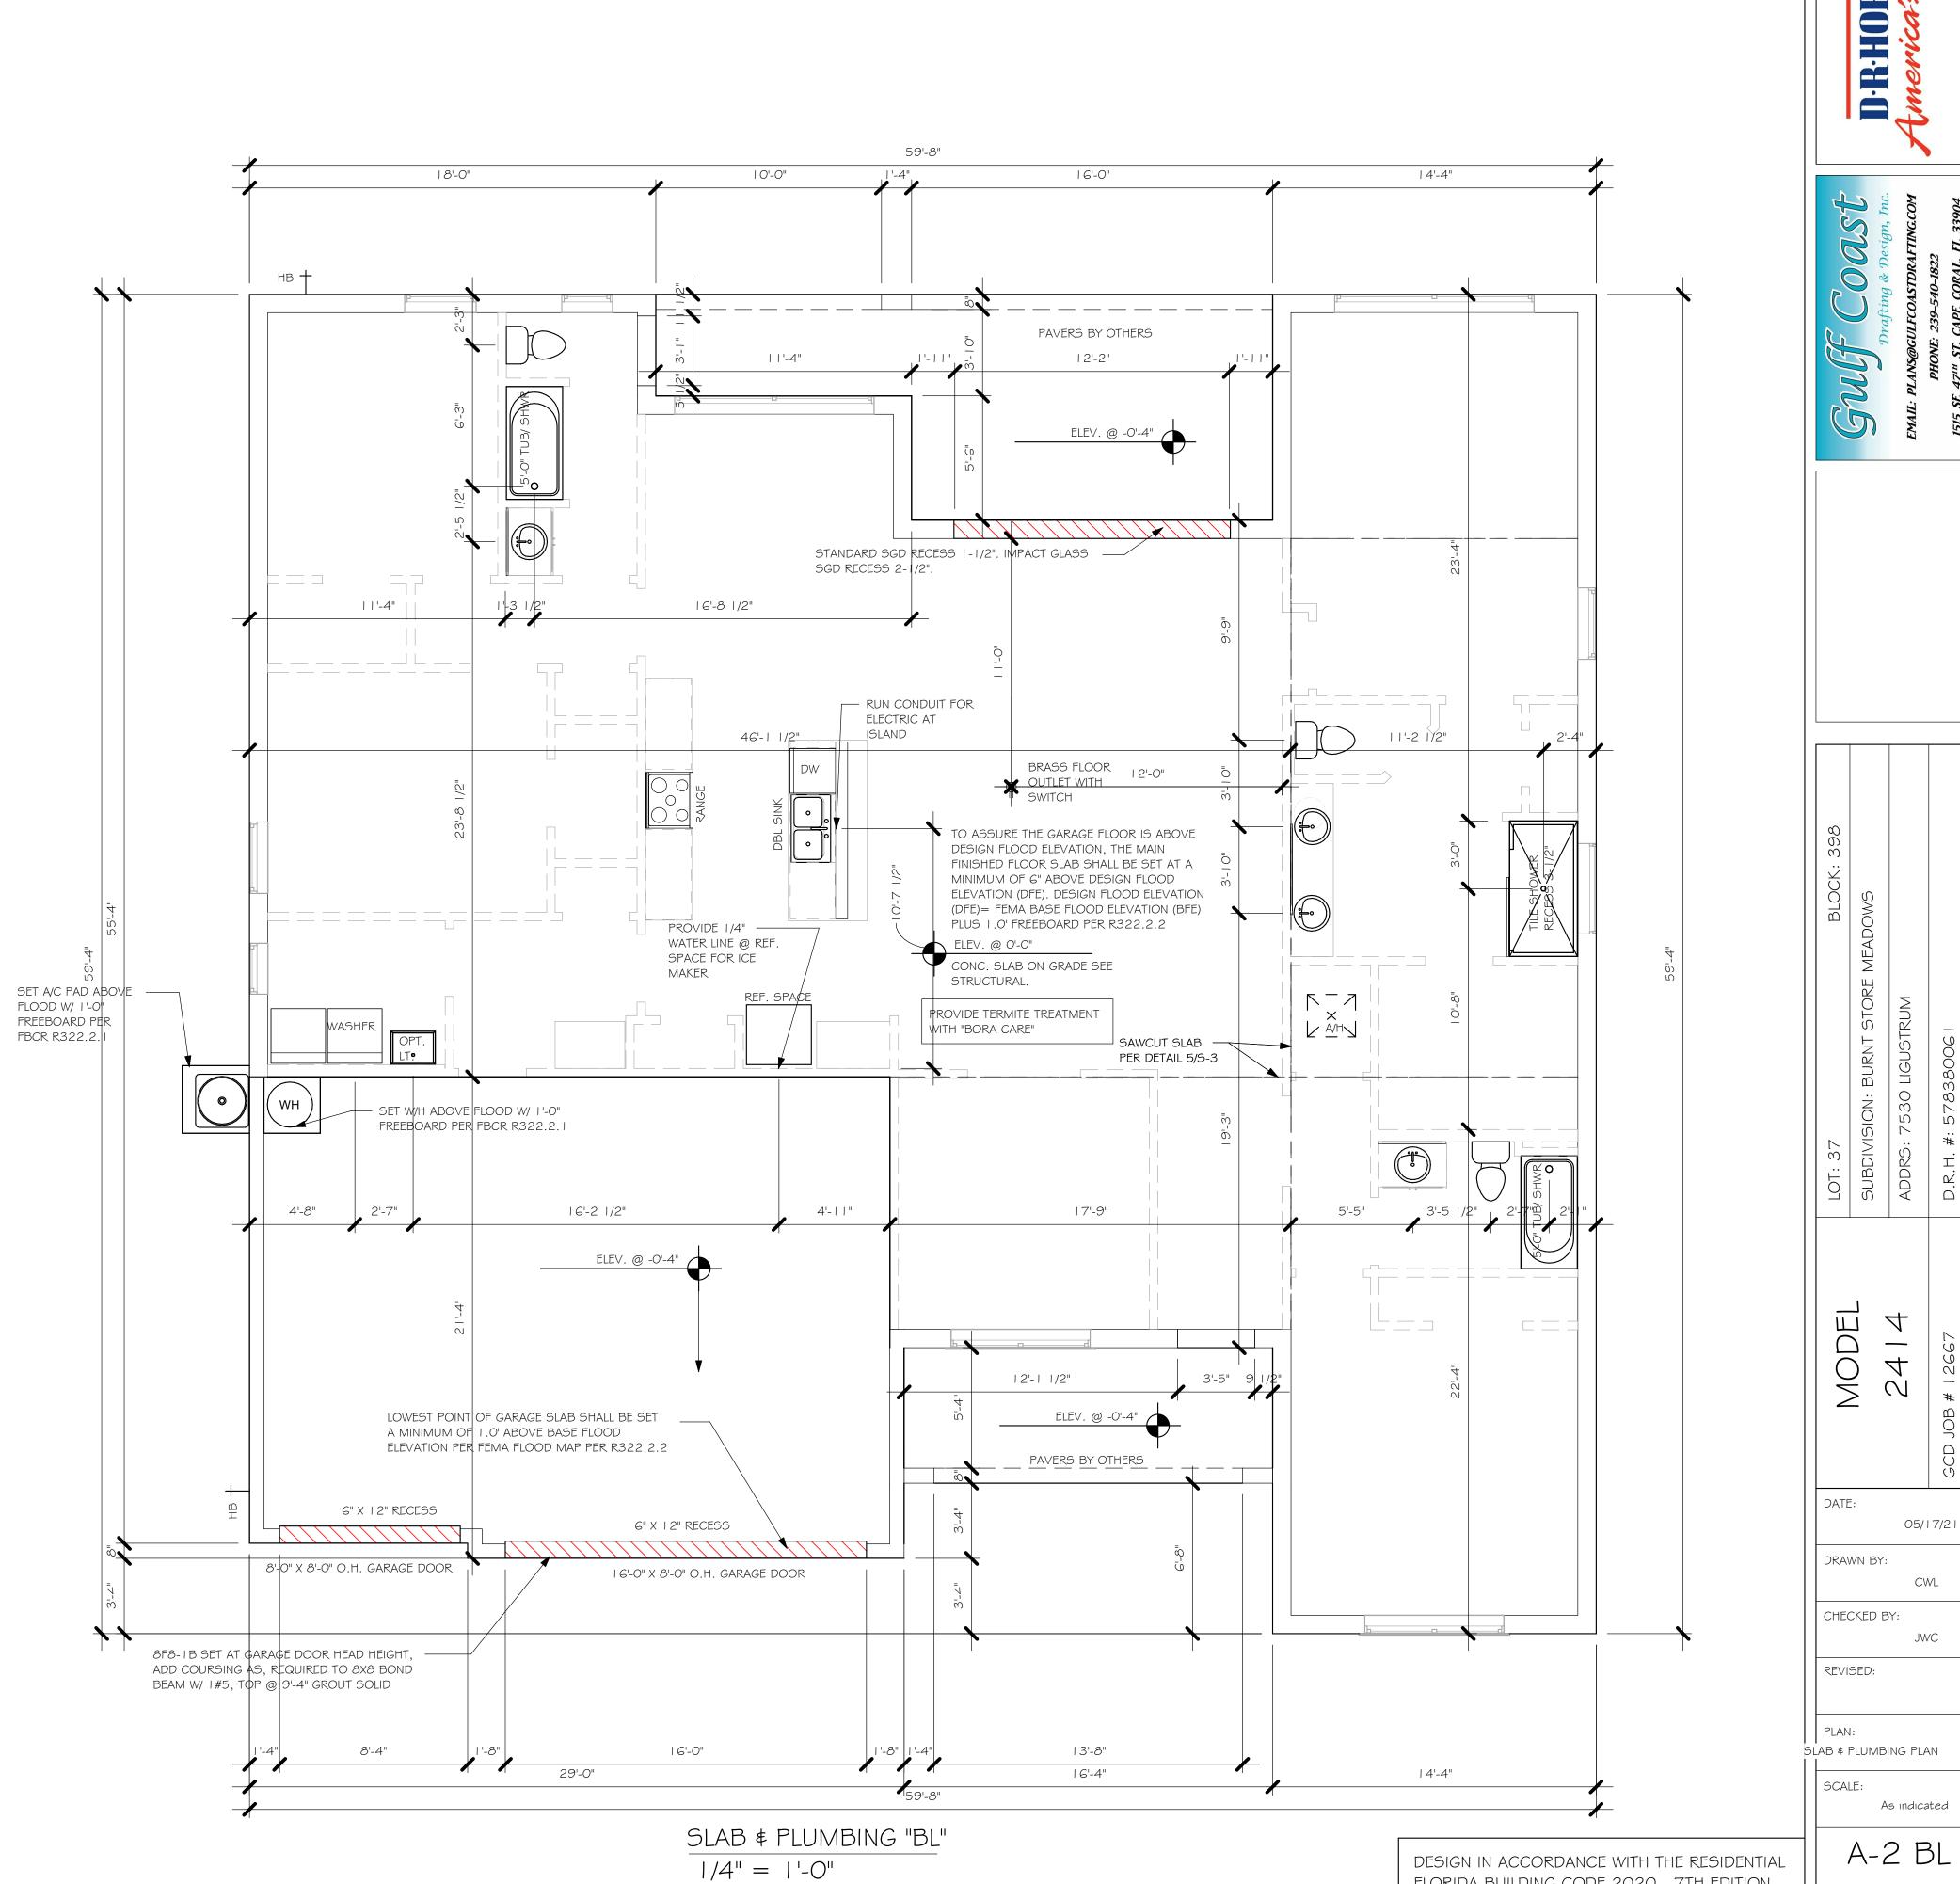

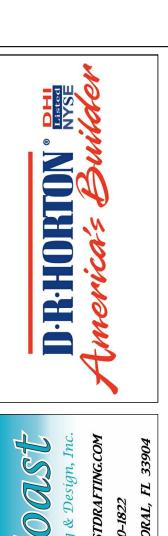

CWL

JWC

FLORIDA BUILDING CODE 2020 - 7TH EDITION

	WINDOW SCHEDULE									
MARK	DESCRIPTION	MANUFACTURER	WIDTH	HEIGHT	COMMENTS	QTY				
А	2-35 SH		9'-0"	5'-3"		2				
В	48" X 16"	FIXED GLASS	4'-2"	1'-6"		1				
С	1/2 33 SH		2'-5"	3'-5"		2				
D	25 SH		3'-4"	5'-5"		3				
E	2-25 SH		6'-4"	5'-3"		1				
F	2-26 SH		6'-4"	6'-4"		I				

DOOD HEADEDC					
DOOR HEADERS					
6'-8" BI-FOLD	HEADER HEIGHT	82" A.F.F.			
6'-8" SWING	HEADER HEIGHT	82 I/2" A.F.F.			
8'-0" SWING	HEADER HEIGHT	98 1/2" A.F.F.			

# PLAN NOTES

- VERIFY ALL ROUGH OPENING DIMENSIONS FOR ALL WINDOWS AND DOORS
- PROVIDE SAFETY GLAZING WITHIN 24" FROM EXI PER FLORIDA BUILDING CODE R 308.4.2.
- PROVIDE SAFETY GLAZING AT BATH/ SHOWER PER FLORIDA BUILDING CODE R 308.4.5.
- NON BEARING INTERIOR FRAME WALLS SHALL BE FRAMED W/ WOOD OR METAL STUDS. SPACING SHALL NOT EXCEED 24" O.C. (NON BEARING WALLS ONLY)
- PROVIDE DEAD WOOD IN ATTIC FOR OVERHEAD GARAGE DOOR HARDWARE
- 6) KITCHEN KNEE WALL TO BE FRAMED W/ TOP @
- INSTALL SMOOTH WALLS IN KITCHEN AND ALL

RESISTANT PER SEC. R702.3.5


34 I/2" A.F.F.

BATHROOM AREAS

OR EQUIVALENT

- WHERE DRYWALL CEILING IS APPLIED TO TRUSSES @ 24" O.C. USE 5/8" DRYWALL OR 1/2" SAG
- THE GARAGE SHALL BE SEPARATED FROM THE RESIDENCE \$ ATTIC BY NOT LESS THEN 1/2" GYPSUM BOARD APPLIED TO THE GARAGE SIDE. GARAGES BENEATH HABITABLE ROOMS SHALL BE SEPARATED WITH NOT LESS THAN 5/8" TYPE "X" GYPSUM BOARD OR EQUIVALENT. WHERE THE SEPARATIION IS A FLOOR - CEILING ASSEMBLY, THE STRUCTURE SUPPORTING THE SEPARTION SHALL ALSO BE PROTECTED BY NOT LESS THAN 1/2" GYPSOM BOARD
- 10) INSTALL 1 3/8" THICK SOLID WOOD DOOR BETWEEN LIVING AND GARAGE PER FLORIDA BUILDING CODE
- I I) ALL WINDOWS INSTALLED 72" ABOVE GRADE MUST COMPLY WITH R3 | 2.2 MIN 24" SILL HEIGHT OR PROVIDED WITH AN APPROVED WINDOW FALL PREVENTION DEVICE
- 12) ALL CLOSET SHELVES TO BE 12". ALL PANTRY \$ LINEN TO BE (4)-16" SHELVES 18" O.F.F. W/ 15"
- 13) ALL MECHANICAL AND ELECTRICAL EQUIPMENT TO BE INSTALLED AT OR ABOVE FLOOD PLUS 1'-O" FREEBOARD.

CABINET BACKING				
KITCHEN UPPER TOP @ 84" BASE TOP @ 35"				
MASTER BATH	UPPER	BASE TOP @ 35"		
GUEST BATH UPPER		BASE TOP @ 31"		
LAUNDRY ROOM	BASE			

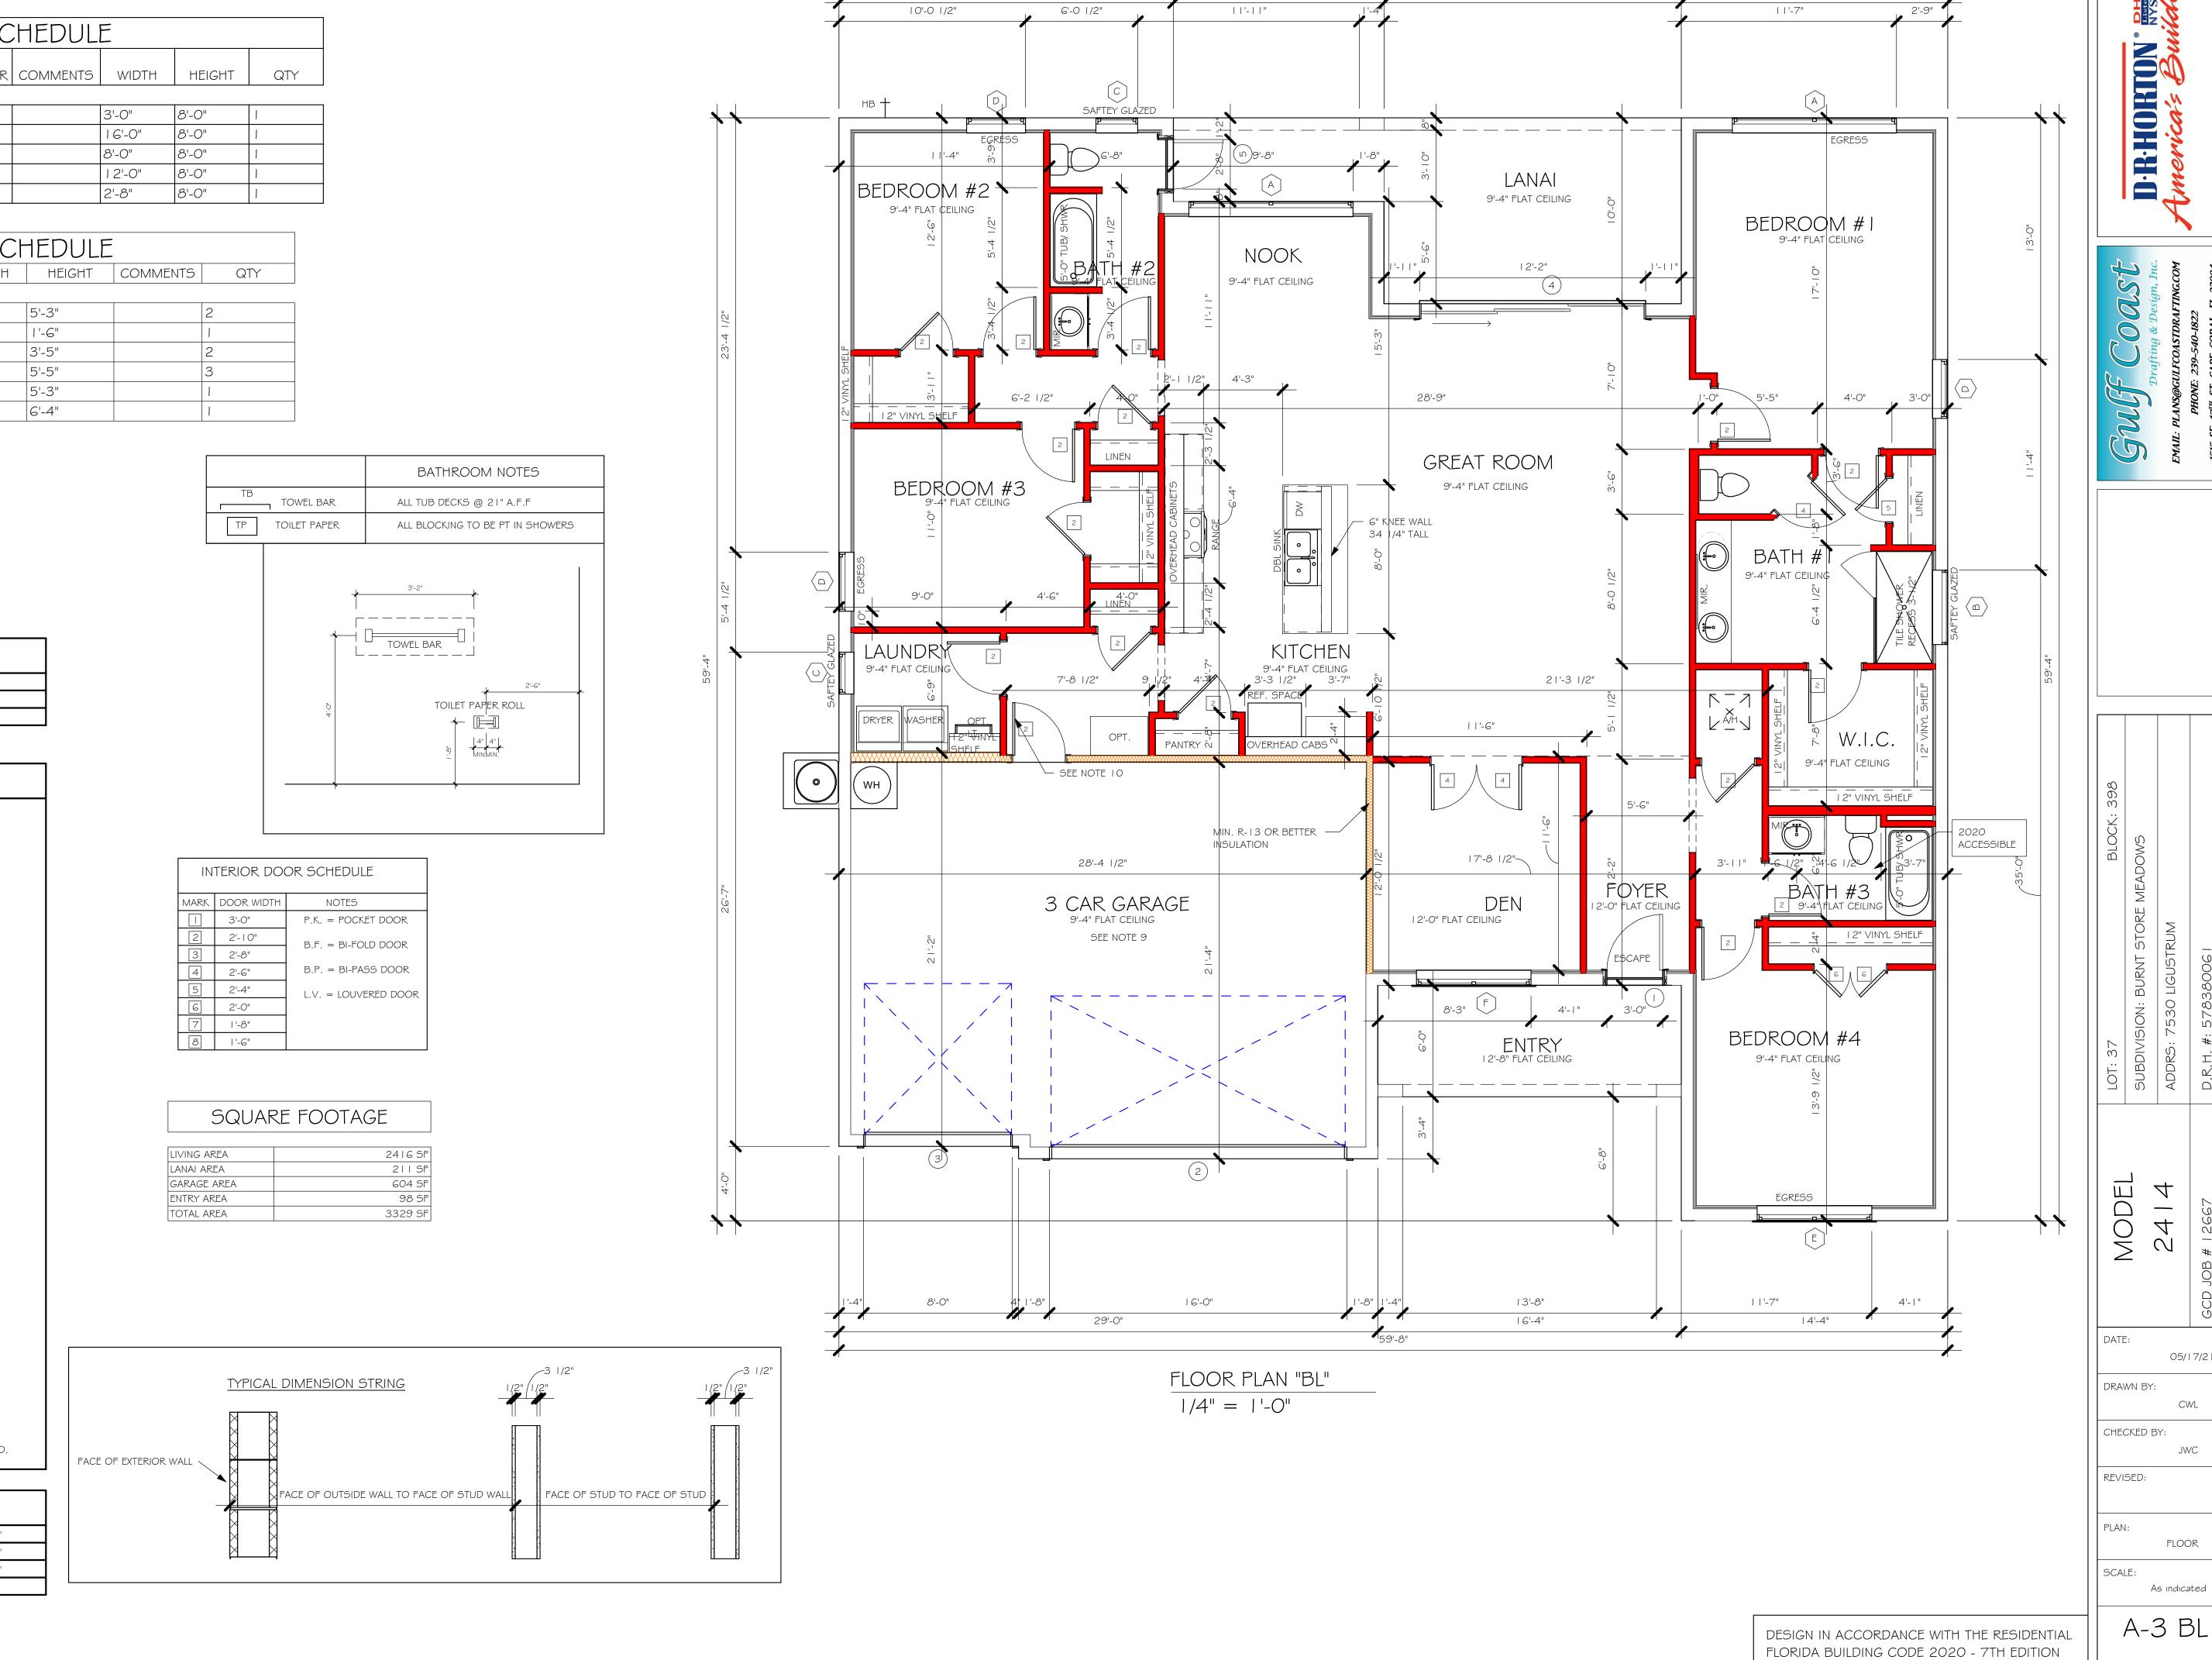

16'-0"

14'-4"


05/17/21

CWL

JWC

FLOOR

BEARING HEIGHT					
	= BEARING @ 9'-4"				
	= INTERIOR BEARING @ 9'-4"				
	= BEARING @ 12'-8"				
	= INTERIOR BEARING @ 12'-8"				

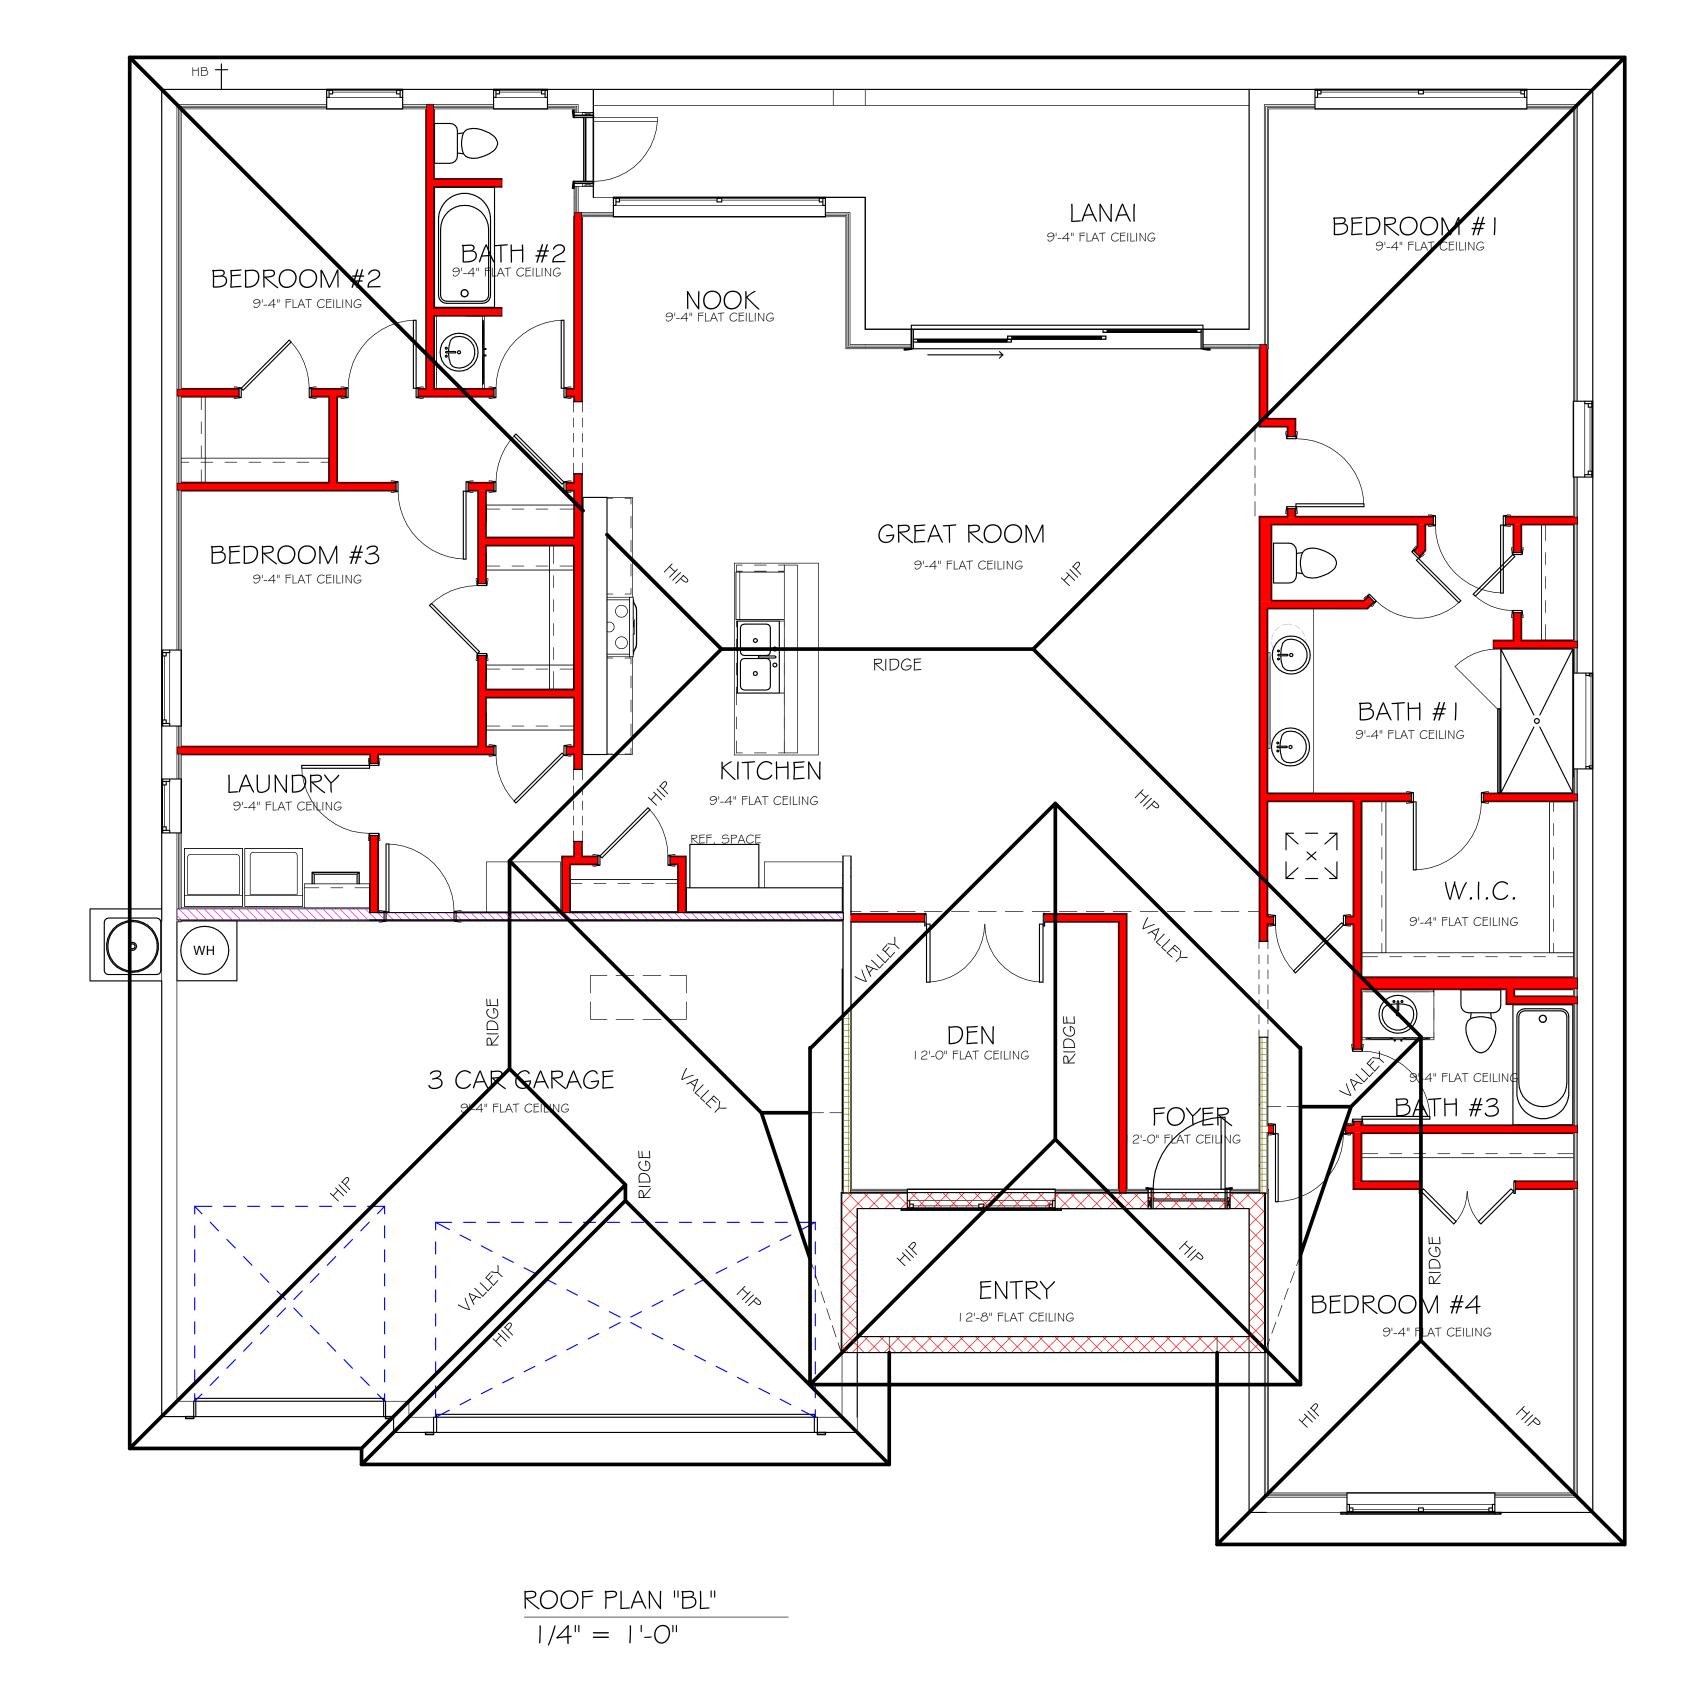

MODEL DATE: 05/17/21 DRAWN BY: CWL CHECKED BY: REVISED: PLAN: ROOF SCALE: As indicated A-4 BL

DESIGN IN ACCORDANCE WITH THE RESIDENTIAL FLORIDA BUILDING CODE 2020 - 7TH EDITION

4' FLUORESCENT LIGHT

2' UNDER COUNTER LIGHT

NOTE: NOT ALL SYMBOLS ARE USED FOR THIS

ARC-FAULT CIRCUIT-INTERRUPTERS AND TAMPER

IN DWELLING UNITS PER N.E.C 210.12 AND 406.11

ALL ELECTRIC, ELECTRICAL EQUIPMENT AND APPLIANCES TO BE SET AT OR ABOVE BASE FLOOD ELEVATIONS PLUS 1'-0" FREEBOARD.


RESISTANT RECEPTACLES SHALL BE INSTALLED

ALL OUTLETS IN WET AREAS AND ALL EXTERIOR OUTLETS TO BE GFI'S.

INSTALL PHONE AND T.V PER CONTRACT. INSTALL ALL ELECTRICAL PER NEC 2014


PROJECT.

ELECTRICAL NOTES:

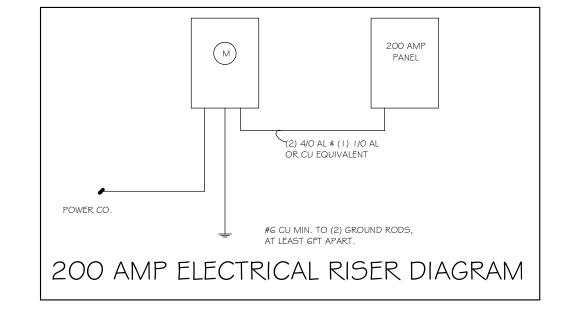

#### ELECTRICAL PLAN 2414

200 AMP SERVICE					
TAG	QUANTITY	PRODUCT			
Α	(17)	(FLUSH MOUNTED LT)			
В	(3)	(VAPORS)			
С	(3)	(PENDANT LIGHT			
D	(15)	(10" MUSHROOMS)			
E	(4)	(24" 3 LT)			
F	(X)	(36" 4 LT)			
G	(X)	(NOT USED)			
Н	(2)	(COACH LIGHTS)			
	(X)	(COACH LIGHTS)			
J	(1)	(J BOX)			
K	(X)	(4' FLUORESCENT)			
L	(X)	(2' FLUORESCENT)			
М	(X)	(5LT CHANDELIER)			
N	(X)	(3 LT)			
0	(X)	(PENDANT/ NOOK)			
Р	(X)	(X)			
Q	(X)	(X)			

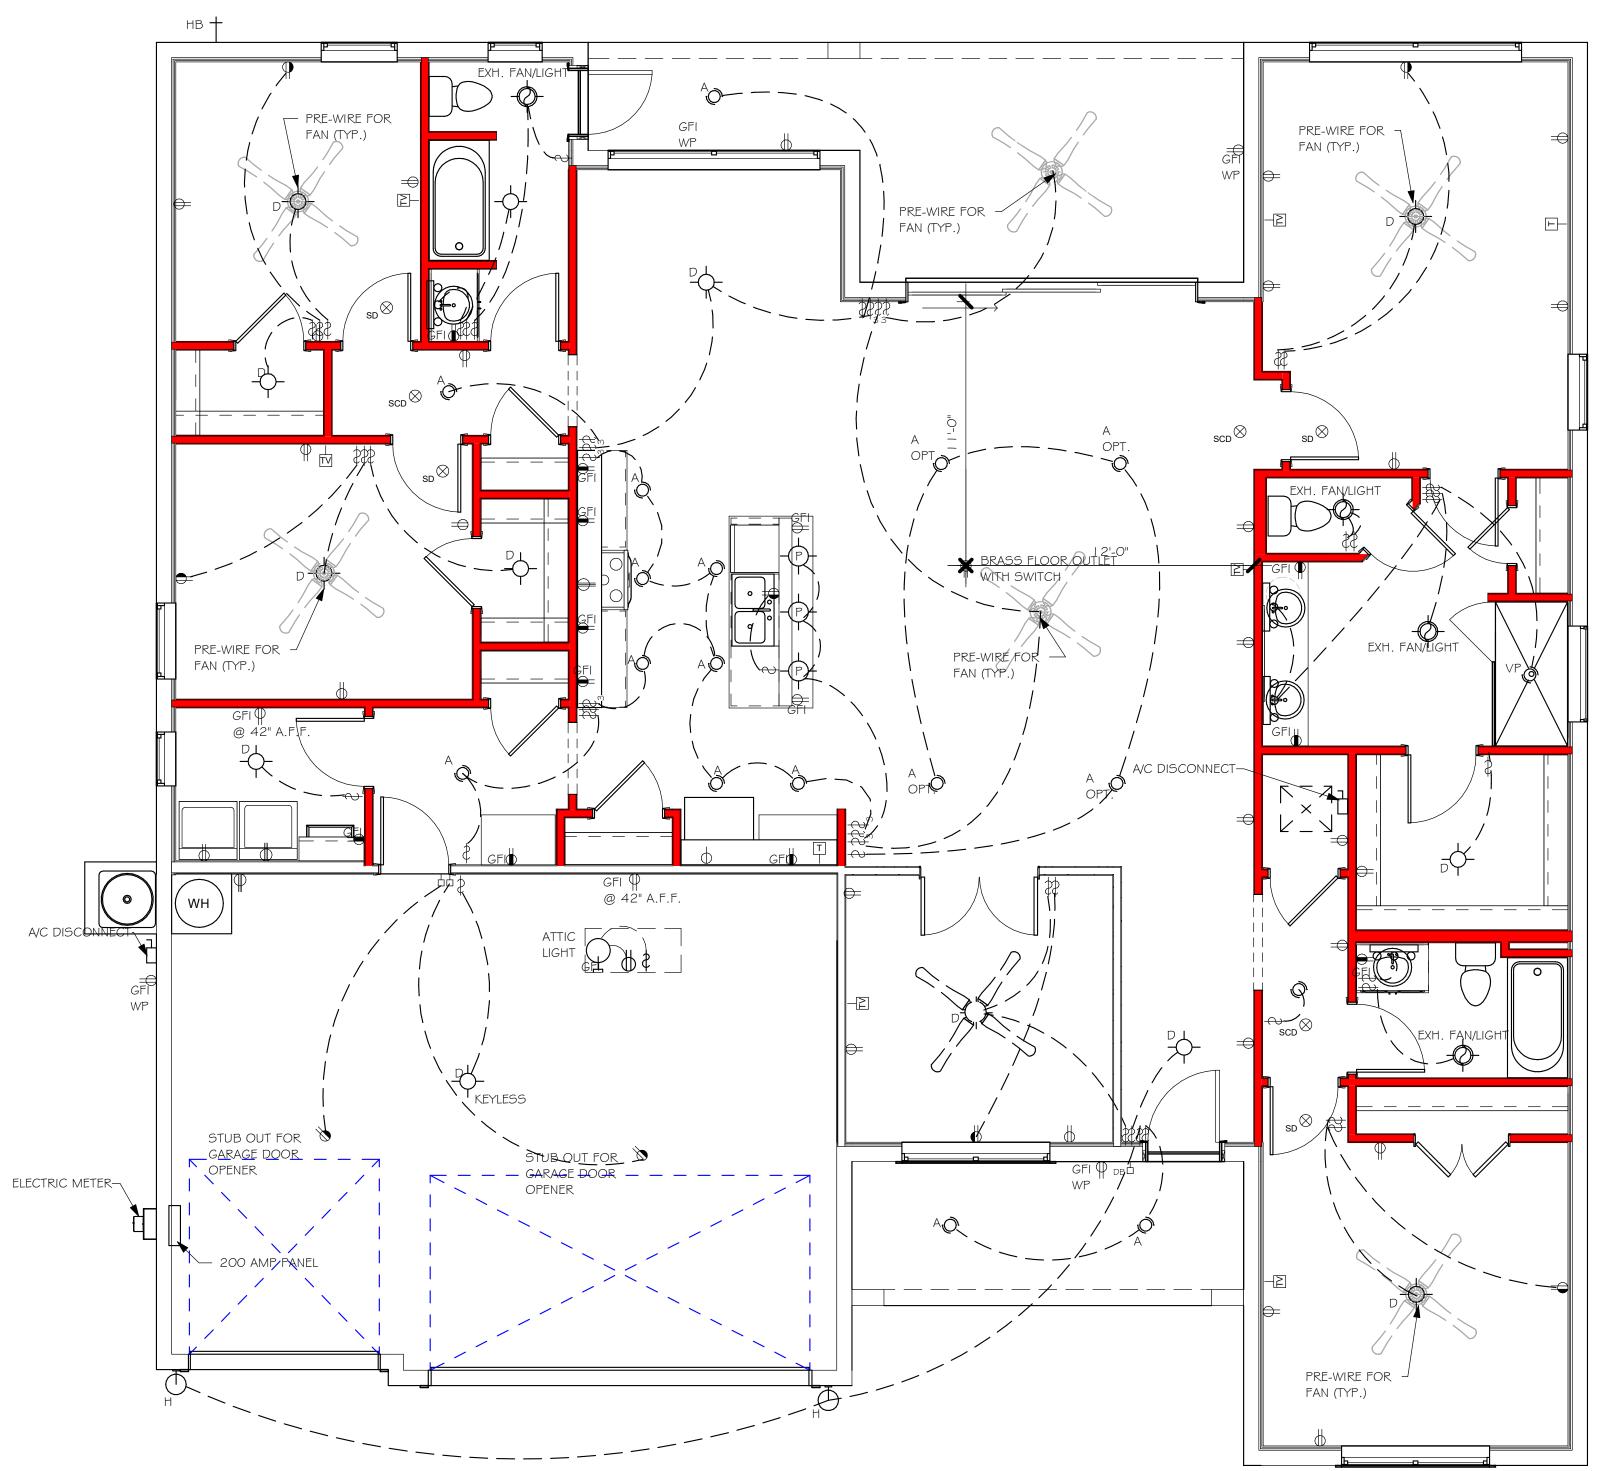

ELECTRICAL PLAN "BL" 1/4" = 1'-0"

DESIGN IN ACCORDANCE WITH THE RESIDENTIAL FLORIDA BUILDING CODE 2020 - 7TH EDITION

MODEL 05/17/21


DATE: DRAWN BY: CWL

CHECKED BY: JWC

REVISED:

ELECTRICAL SCALE: As indicated

A-5 BL

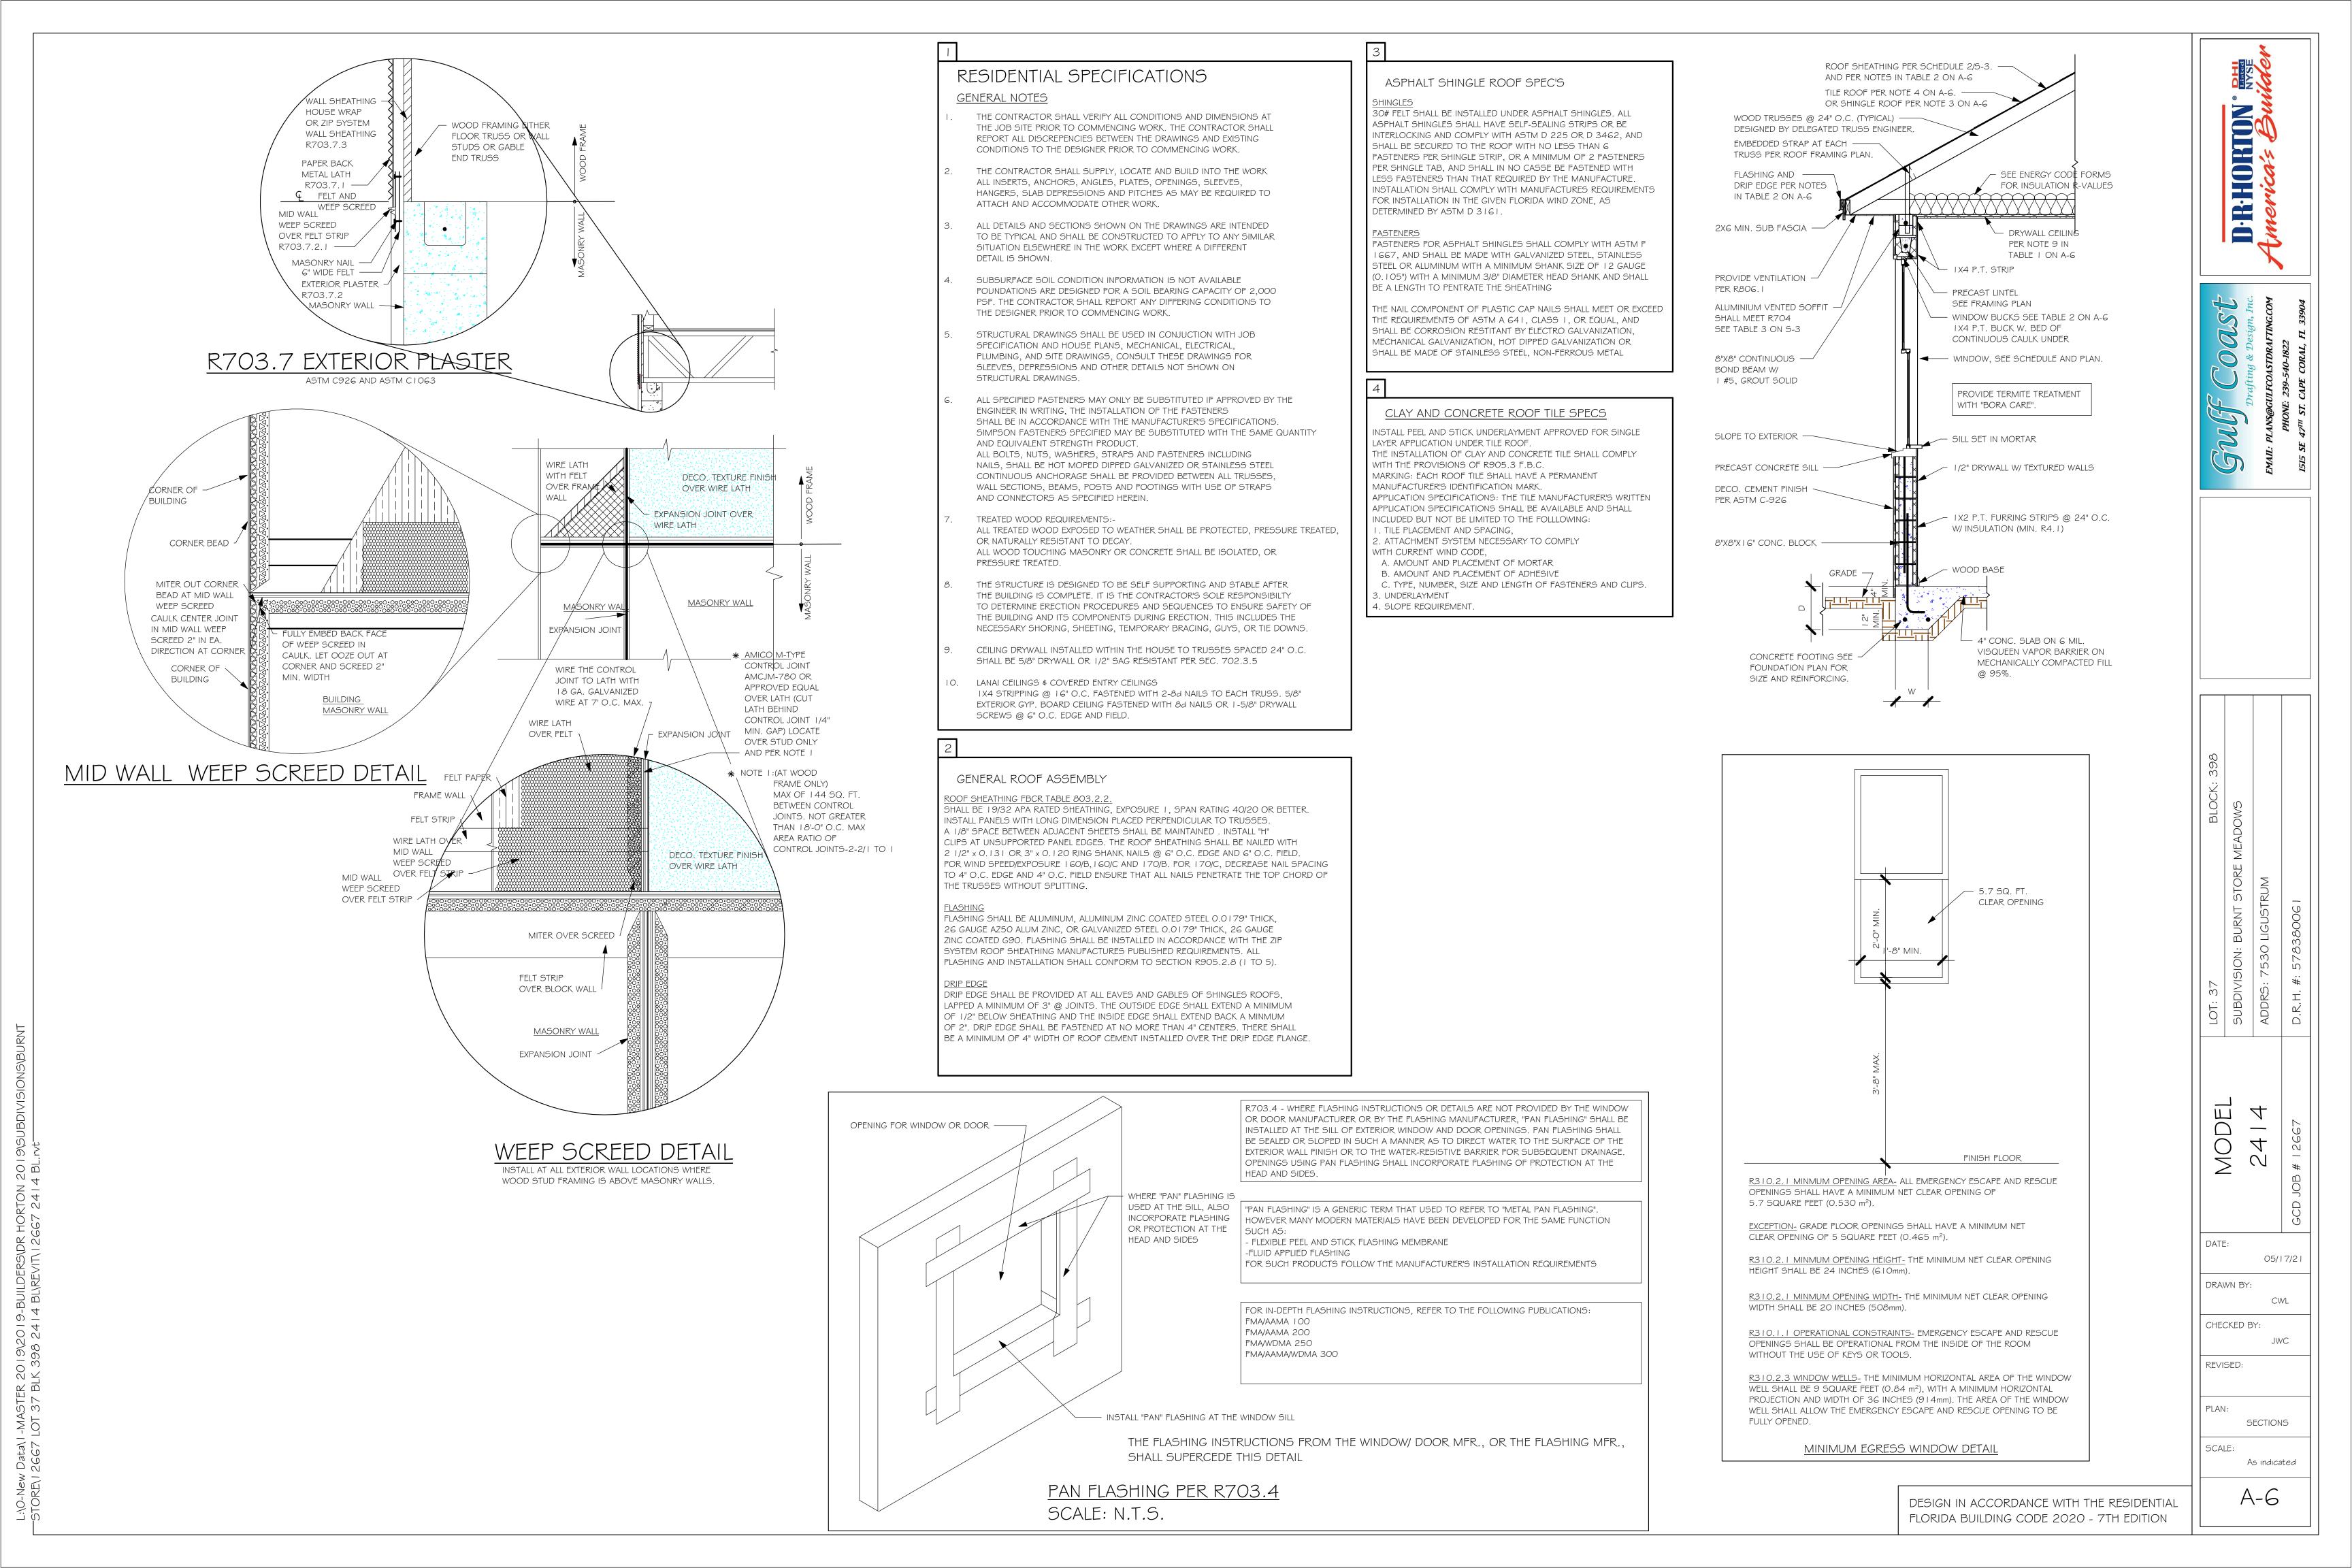

## FOUNDATION PLAN

#### SCALE: 1/4" = 1'-0"


CURB IS OPTIONAL \$ NOT INCLUDED

IN FOOTING DIMENSIONS

- PLAN NOTES:
- TOP OF GROUND FLOOR SLAB DATUM ELEVATION 0'-0"
   "F#" DENOTES CONTINUOUS WALL FOOTING TYPE PER SCHEDULE THIS SHEET.
- 3. PROVIDE #5 VERTICAL REINFORCING AT DOT LOCATIONS SHOWN ON PLAN FROM FOOTING TO BOND BEAM.
- ALL DIMENSIONS ARE TO OUTSIDE FACE OF MASONRY WALLS. SOME SLAB EDGES MAY EXTEND BEYOND FACE OF WALL.

FOR DIMENSIONS OF ROUGH OPENINGS IN MASONRY WALLS, COORDINATE WITH WINDOW

PROVIDE PRESSURE TREATED BUCKS AT WINDOWS/ DOORS PER DETAIL 7/S-3.

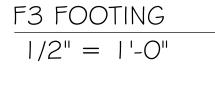

#5 DOWEL WITH 7" HOOK, EMBED

5" MIN. BELOW GARAGE FLOOR


VARIES WITH

SLOPE OF FLOOR


2 #5 CONT. W/ — 3" CLEAR COVER.

	PAD FOOTING SCHEDULE								
USED	TVDE	LENCTH	WIDTH	DEPTH	вотт	OM REINF.	DEMARKS		
S	ITPE	LENGTH	חוטוא	DEPIR	LONG WAY	SHORT WAY	REMARKS		
X	<b>(A</b> )	2'-6"	2'-6"	1'-0"	3-#5	3-#5	-		
X	( <b>B</b> )	3'-0"	3'-0"	1'-0"	4-#5	4-#5	-		
X	<b>(C</b> )	3'-6"	3'-6"	1'-0"	4-#5	4-#5	-		
	<b>(D)</b>	4'-0"	4'-0"	1'-2"	5-#5	5-#5	-		
	(E)	5'-0"	5'-0"	1'-2"	6-#5	6-#5	-		


 $\frac{\text{F3 WITH CURB AT GARAGE}}{1/2" = 1'-0"}$ 

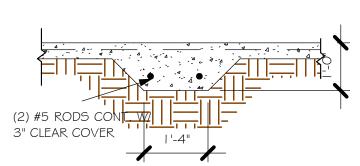

 $\frac{\text{F5 FOOTING}}{1/2" = 1'-0"}$ 

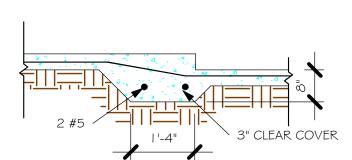


 $\frac{\text{F6 STEP DOWN}}{1/2" = 1'-0"}$ 

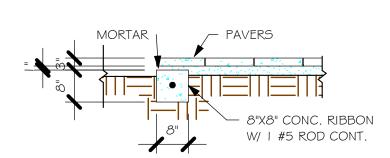


"P" PAVERS DETAIL ENTRY/LANAI 1/2" = 1'-0"

USED	TYPE	LENGTH	WIDTH	DEPTH	BOTTOM REINFORCING	SHAPE	
	F1	CONT.	1'-4"	0'-8"	2-#5		
	F2	CONT.	1'-8"	0'-10"	2-#5		
X	F3	CONT.	1'-0"	1'-8"	2-#5		ADD CURB 1 GARAGE, SE
X	F4	CONT.	1'-4"	1'-8"	2-#5	$\vdash$	DETAIL
X	F5	CONT.	1'-4"	1'-0"	2-#5	<b>F</b>	
X	F6	CONT.	1'-4"	1'-0"	2-#5	<b>#</b>	
,	F6A	CONT.	0'-8"	0'-8"	1-#5		
	TE	CONT.	0'-8"	0'-8"	1-#5		1

PROVIDE CORNER BARS IN FOOTING PER 6/S-3

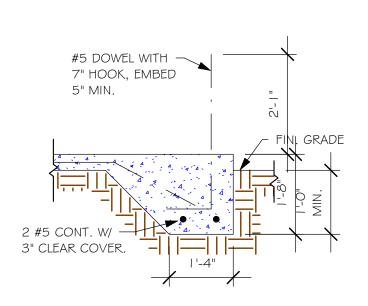

 $\frac{\text{"F4" FOOTING B}}{1/2\text{"} = 1\text{'-0"}}$ 

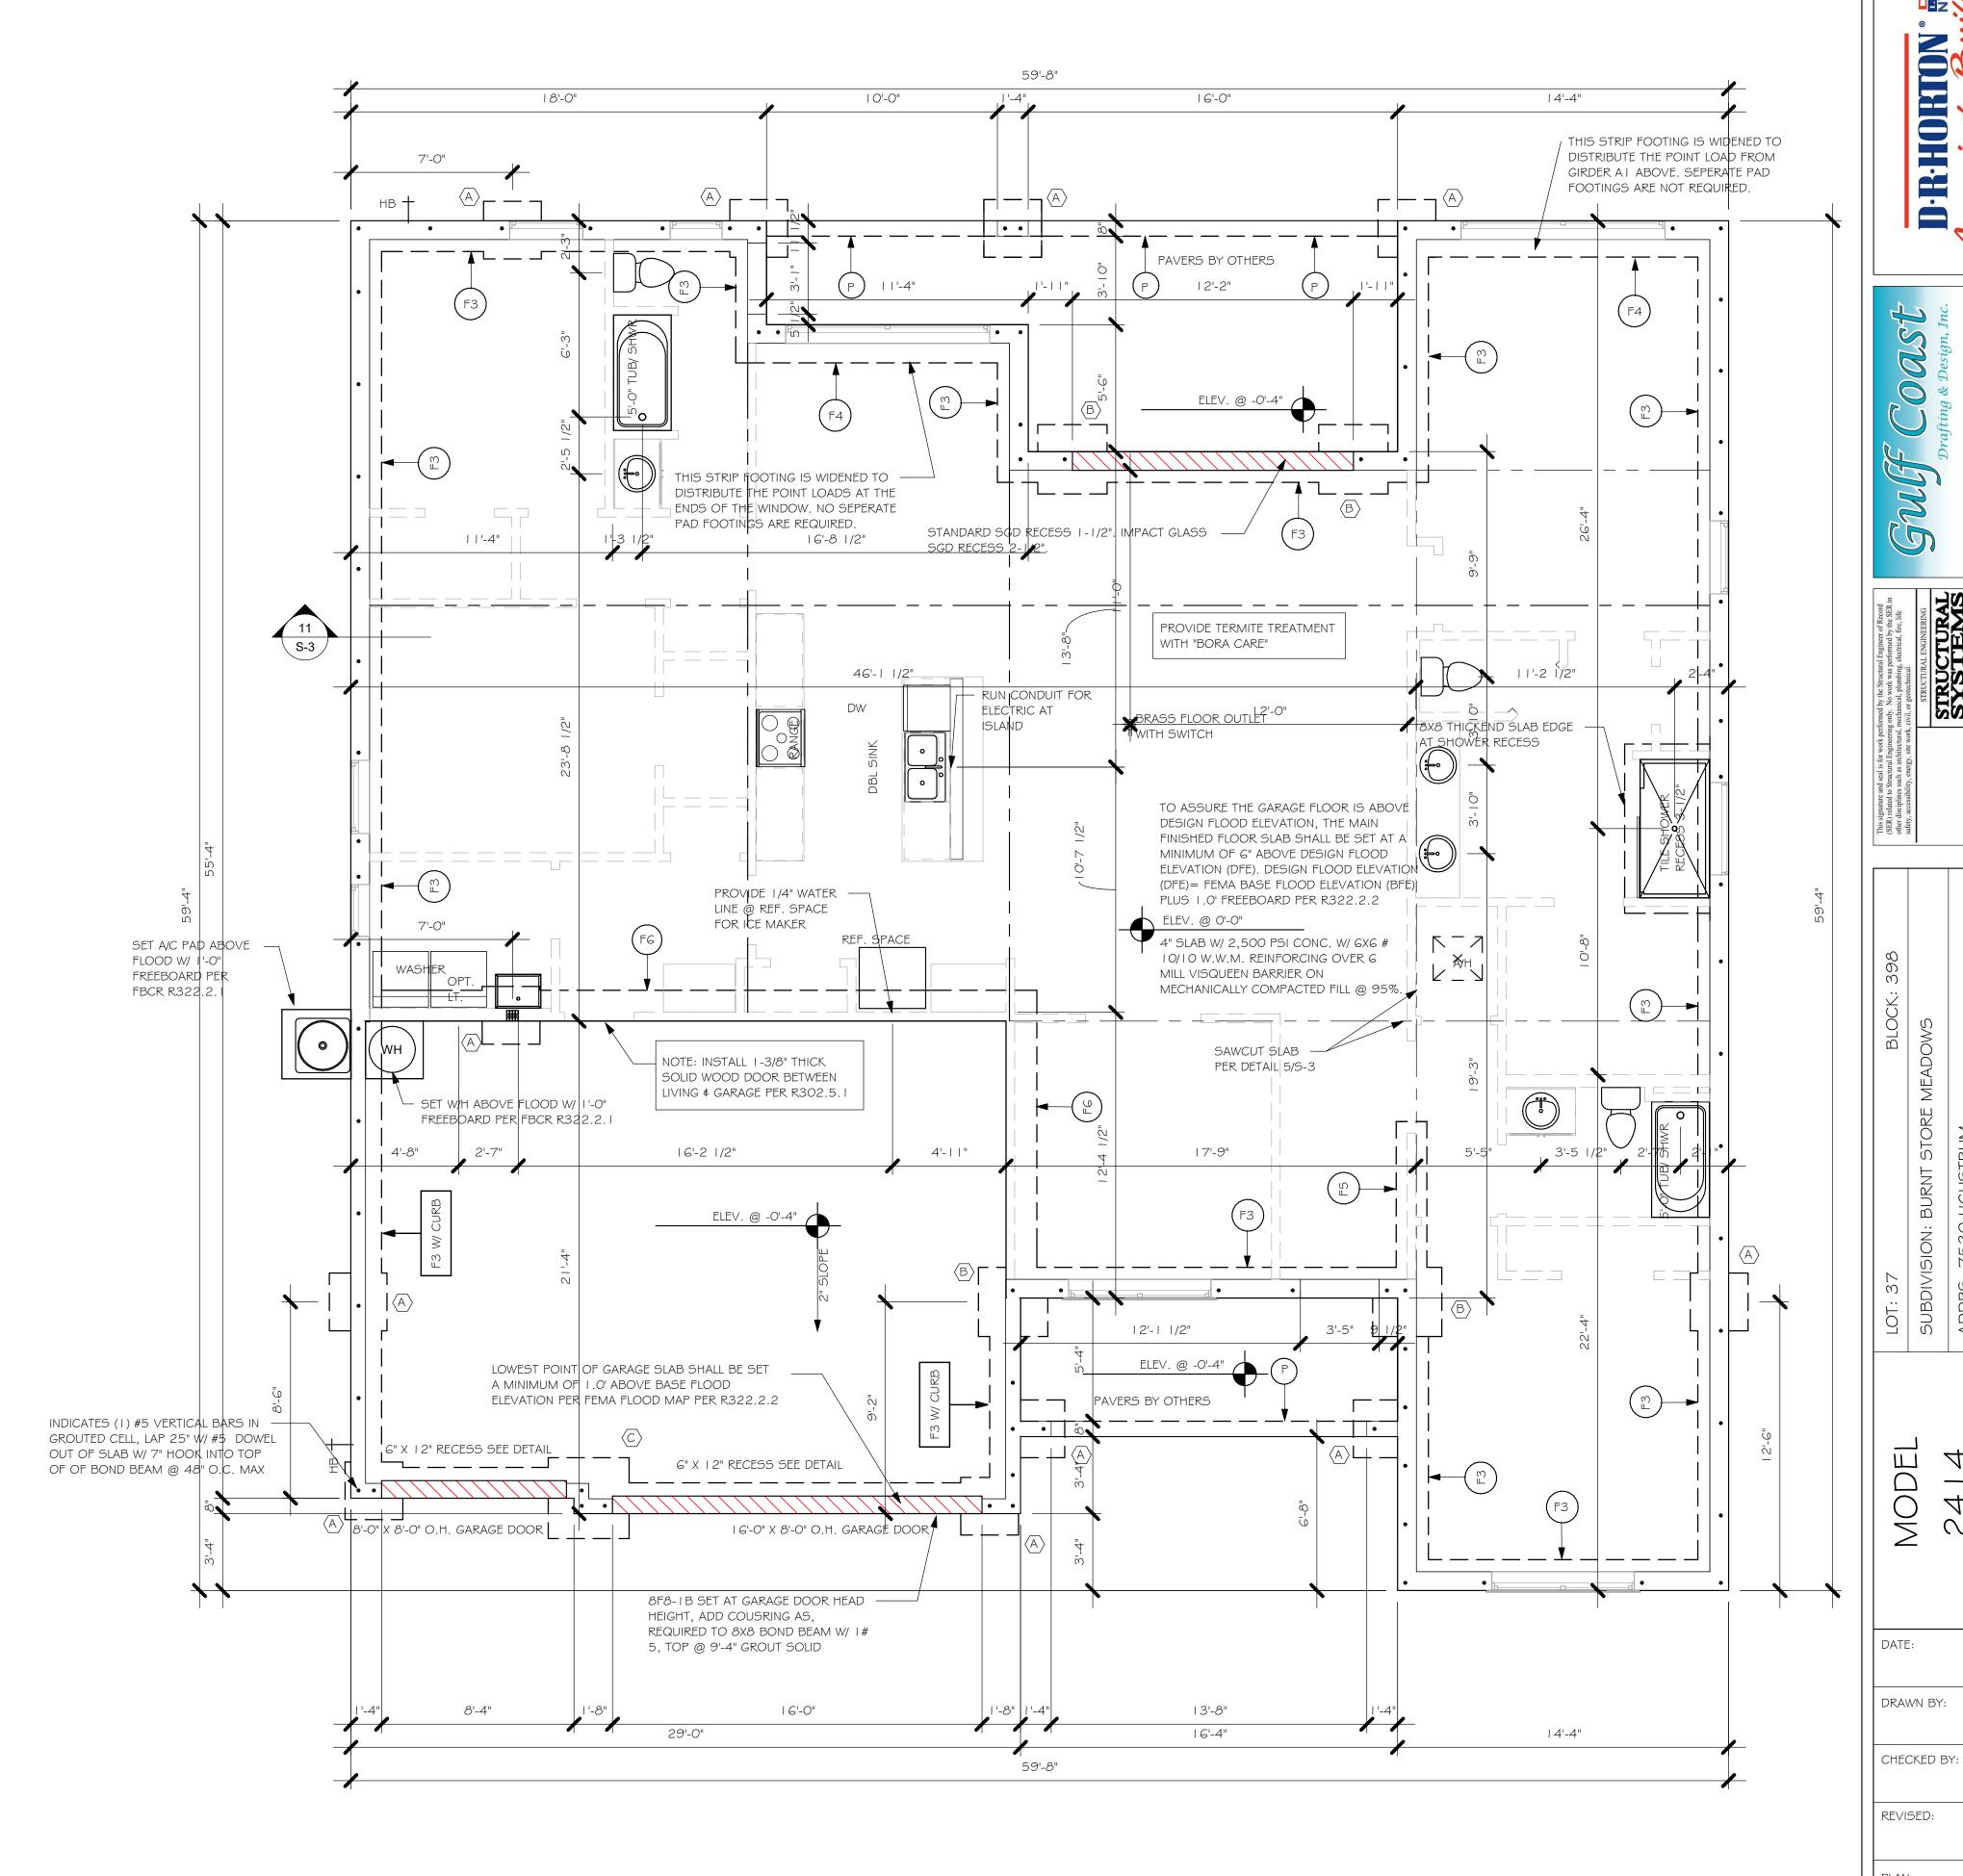

 $\frac{\text{FOUNDATION PLAN "BL"}}{1/4" = 1'-0"}$ 

DESIGN IN ACCORDANCE WITH THE RESIDENTIAL FLORIDA BUILDING CODE 2020 - 7TH EDITION

05/17/21

CWL

JWC


FOUNDATION PLAN

As indicated

BL

SCALE:

L:\O-New Data\I-MASTER 2019\2019-BUILDERS\DR HORTON 2019\SUBDIVISIONS\BI ---STORE\I 2667 LOT 37 BLK 398 2414 BL\REVIT\I 2667 2414 BL.rvt

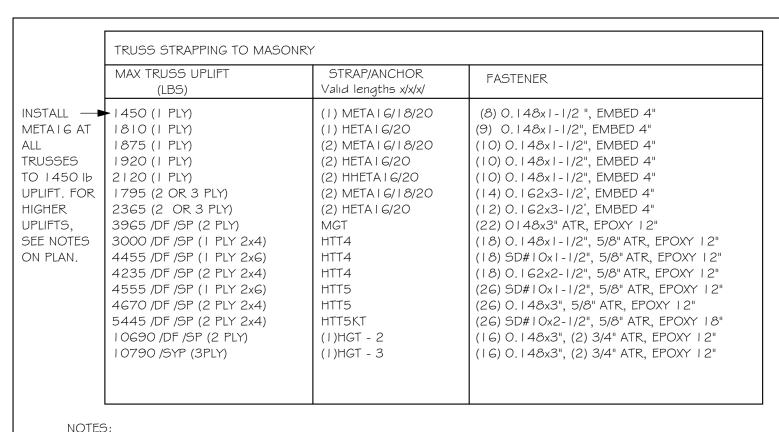

PROVIDE A STRAP FROM THE ABOVE LIST AT EACH ROOF TRUSS BEARING POINT, BASED ON THE TRUSS UPLIFT VALUES IN THE SIGNED AND SEALED TRUSS DESIGN PACKAGE AND SUITABLE FOR THE GEOMETRY. EMBED STRAP ON CENTERLINE OF WALL.

- 2. ANY OF THE VALID LENGTHS SHOWN MAY BE USED IN PLACE OF THE LENGTH SPECIFIED ON PLAN.
  3. CONNECTORS ARE SIMPSON STRONG TIE. ALL CONNECTORS SHALL BE INSTALLED IN STRICT ACCORDANCE WITH SIMPSON PRINTED INSTUCTIONS. SUBSTITUTIONS MUST BE APPROVED IN
- WRITING BY THE ENGINEER OF RECORD.

  WHERE EMBEDDED STRAPS ARE MISSING, OR MIS-LOCATED, INSTALL RETROFIT STRAP PER 10/S-3.

  PER UPLIFT IN TRUSS ENGINEERING.

SIMPSON CATALOG C-C- 2019


ĺ						
INSTALL AT ALL	TRUSS STRAPPING TO STUDWALL/ WOOD BEAM					
TRUSSES TO 850 Ib UPLIFT.	MAX TRUSS UPLIFT (LBS)	STRAP(S) Valid lengths x/x/x	FASTENER			
FOR HIGHER - UPLIFTS, SEE NOTES ON		(1)MT5   6/20/30 (2) MT5   6/20/30 (3) MT5   6/20/30	(14) 0.148x1-1/2" or 3" EACH STRAP			
PLAN.	1125 2250 3375 4500	(1) HTS20/24/30 (2) HTS20/24/30 (3) HTS20/24/30 (4) HTS20/24/30	(24) 0.148x1-1/2" OR (20) 0.148x3" EACH STRAP			


NOTES:

- PROVIDE A STRAP FROM THE ABOVE LIST AT EACH ROOF TRUSS BEARING POINT, BASED ON THE TRUSS UPLIFT VALUES IN THE SIGNED AND SEALED TRUSS DESIGN PACKAGE.
- 2. ANY OF THE VALID LENGTHS SHOWN MAY BE USED IN PLACE OF THE LENGTH SPECIFIED ON PLAN.
- 3. I I/2" NAIL SHALL BE USED IN 1 PLY LUMBER, 2 PLY LUMBER IS REQUIRED FOR 3" NAILS.
- 4. CONNECTORS ARE SIMPSON STRONG TIE. ALL CONNECTORS SHALL BE

INSTALLED IN STRICT ACCORDANCE WITH SIMPSON PRINTED INSTUCTIONS.

SIMPSON CATALOG C-C- 2019

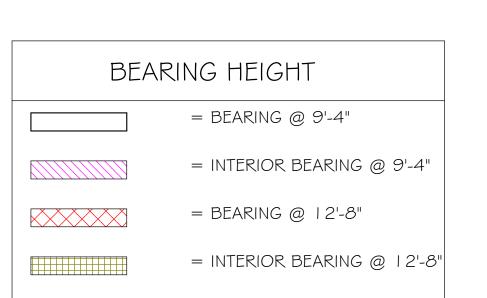


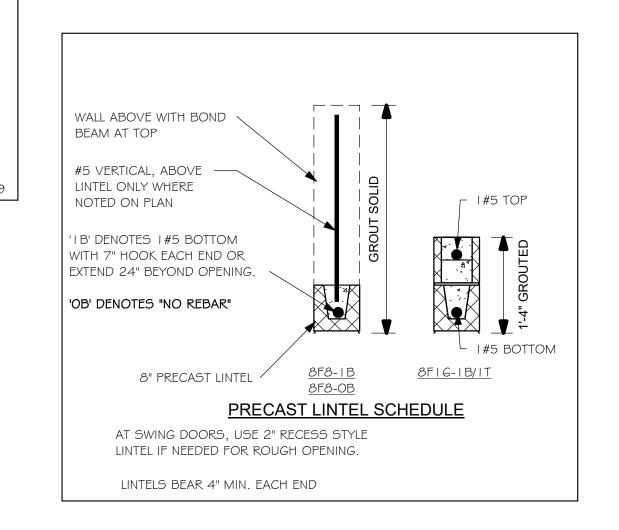


ROOF TRUSS -


ROOF SHEATHING

BEVELLED BLOCKING DETAIL

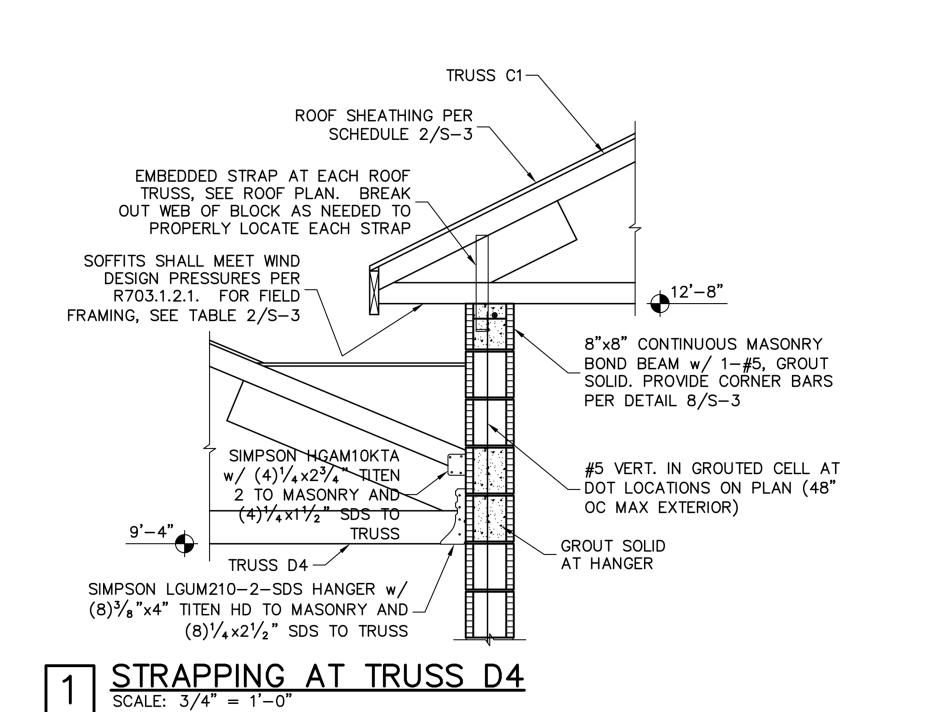

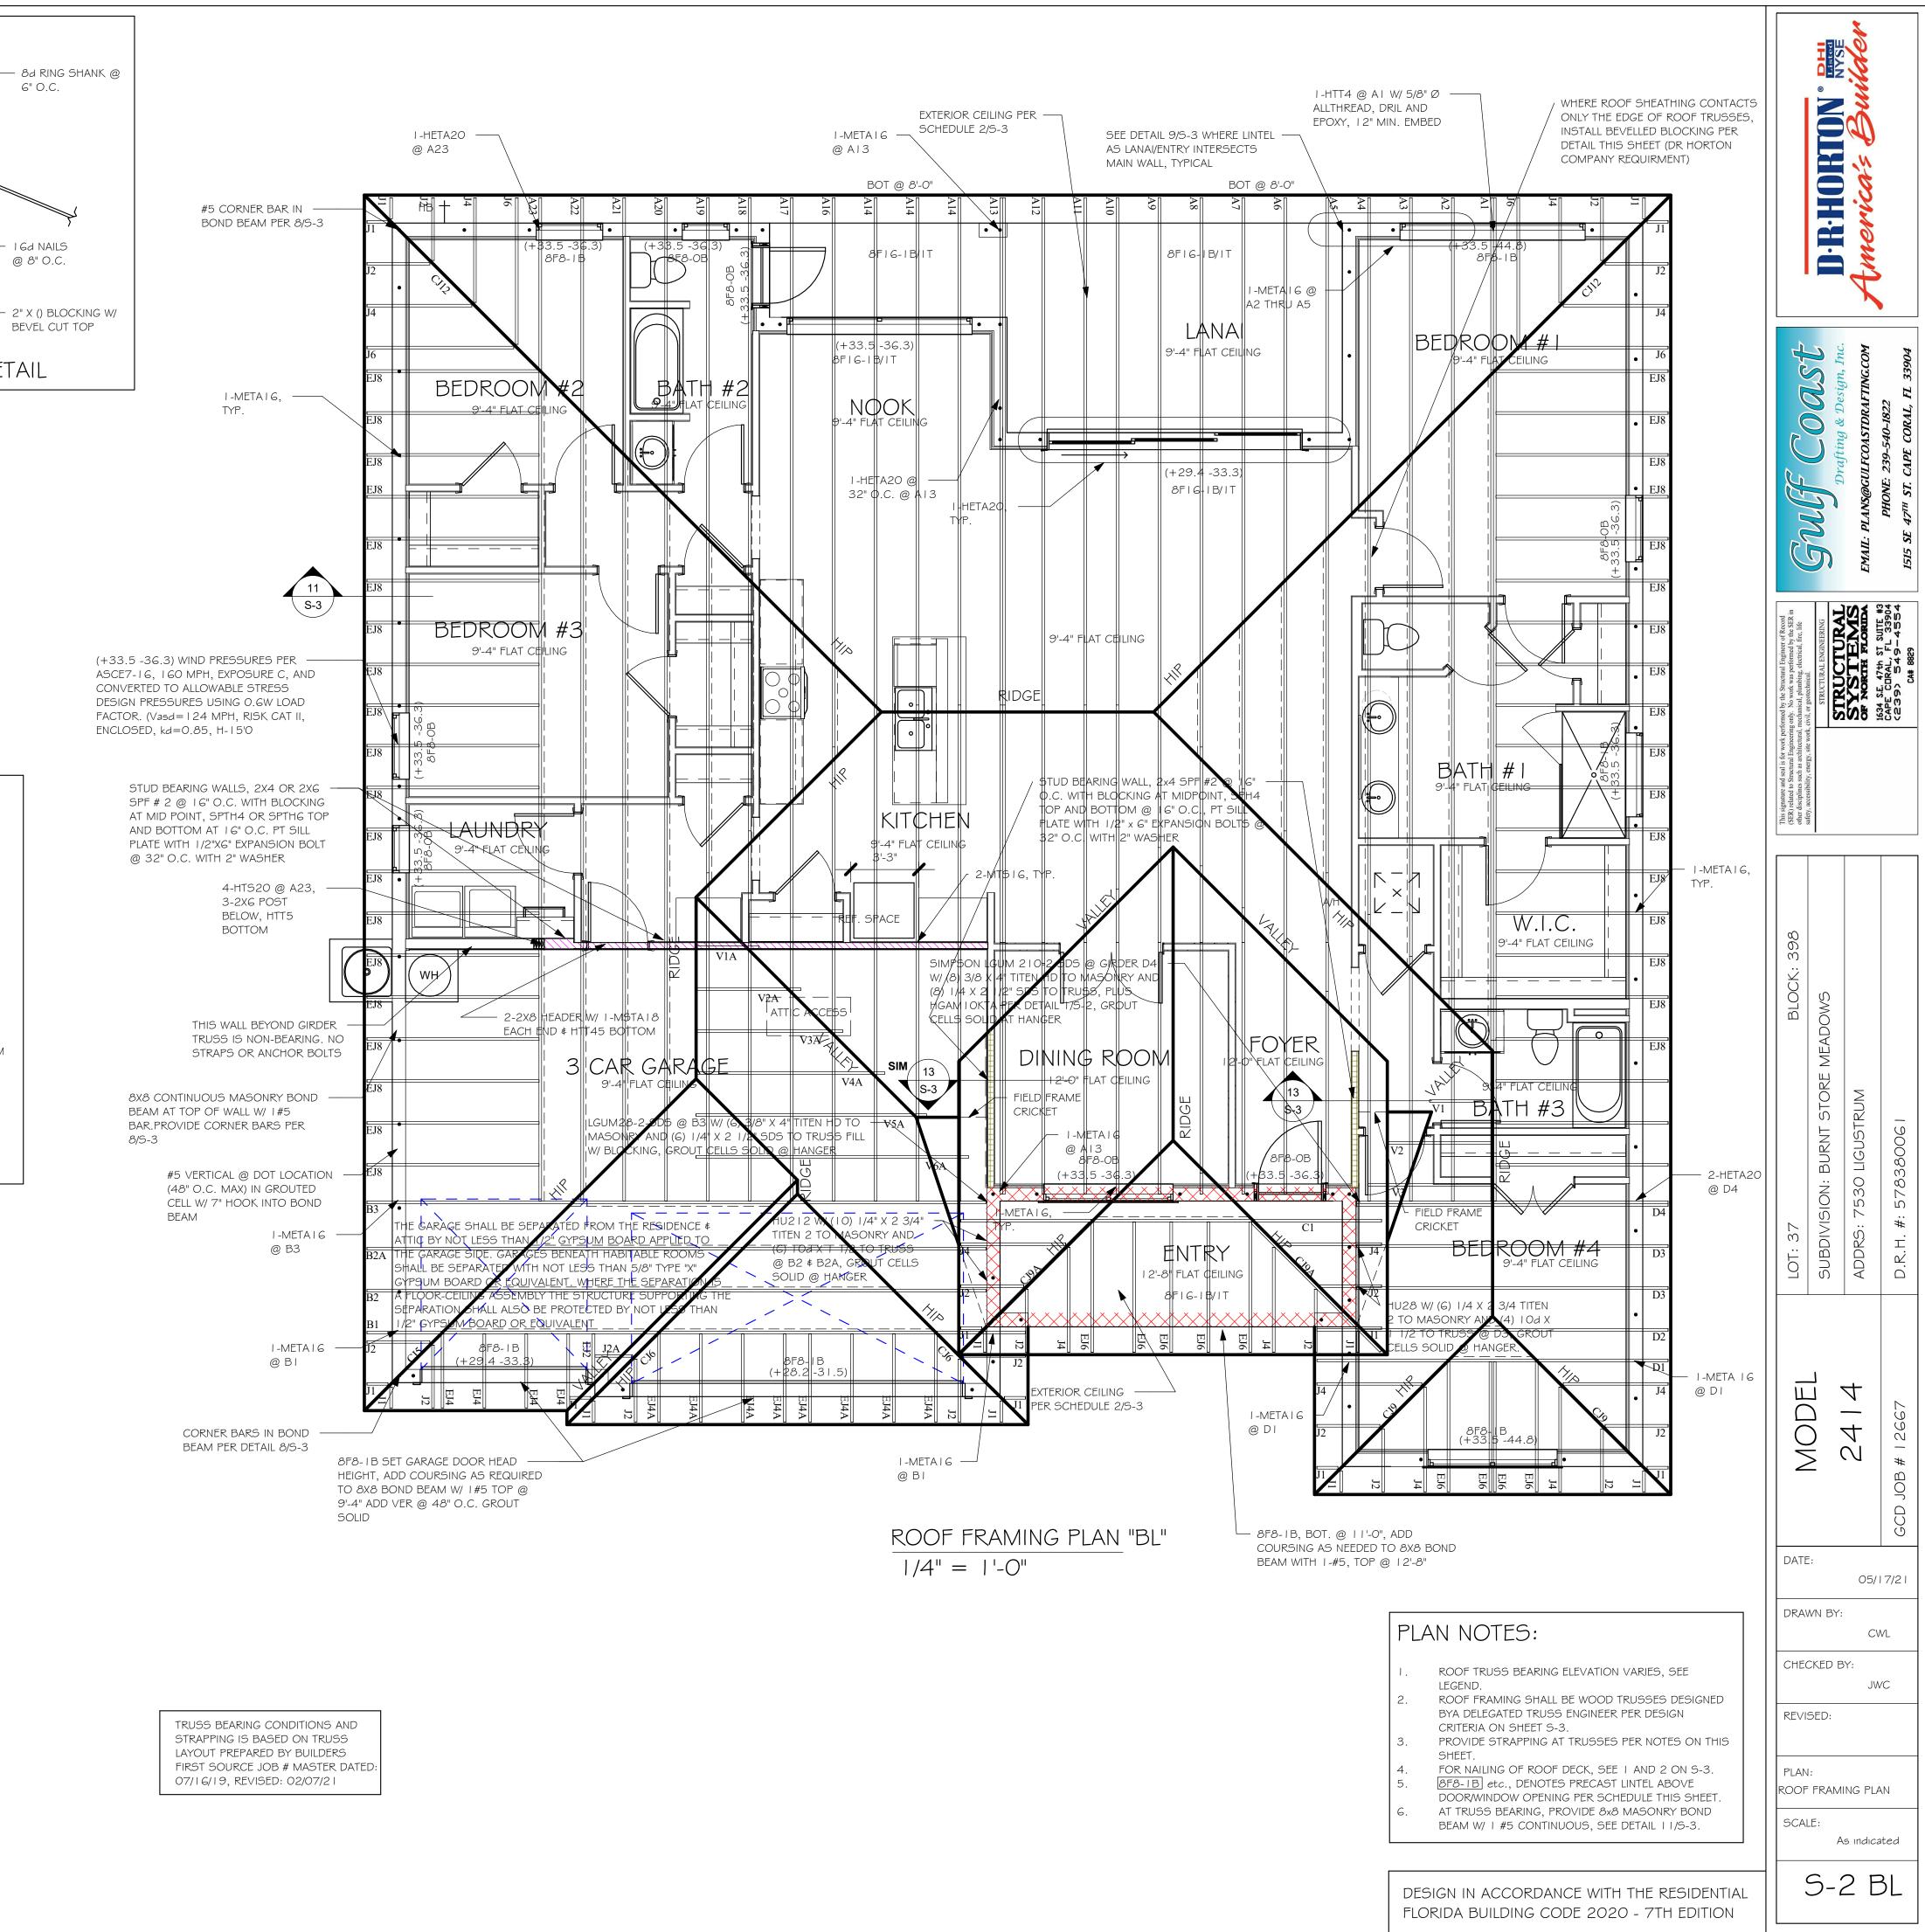

L:\O-New Data\I-MASTER 2019\2019-BUILDERS\DR HORTON 2019\SUBDIVISIONS\BURNT FTSTORE\I 2667 LOT 37 BLK 398 2414 BL\REVIT\I 2667 2414 BL.rvt

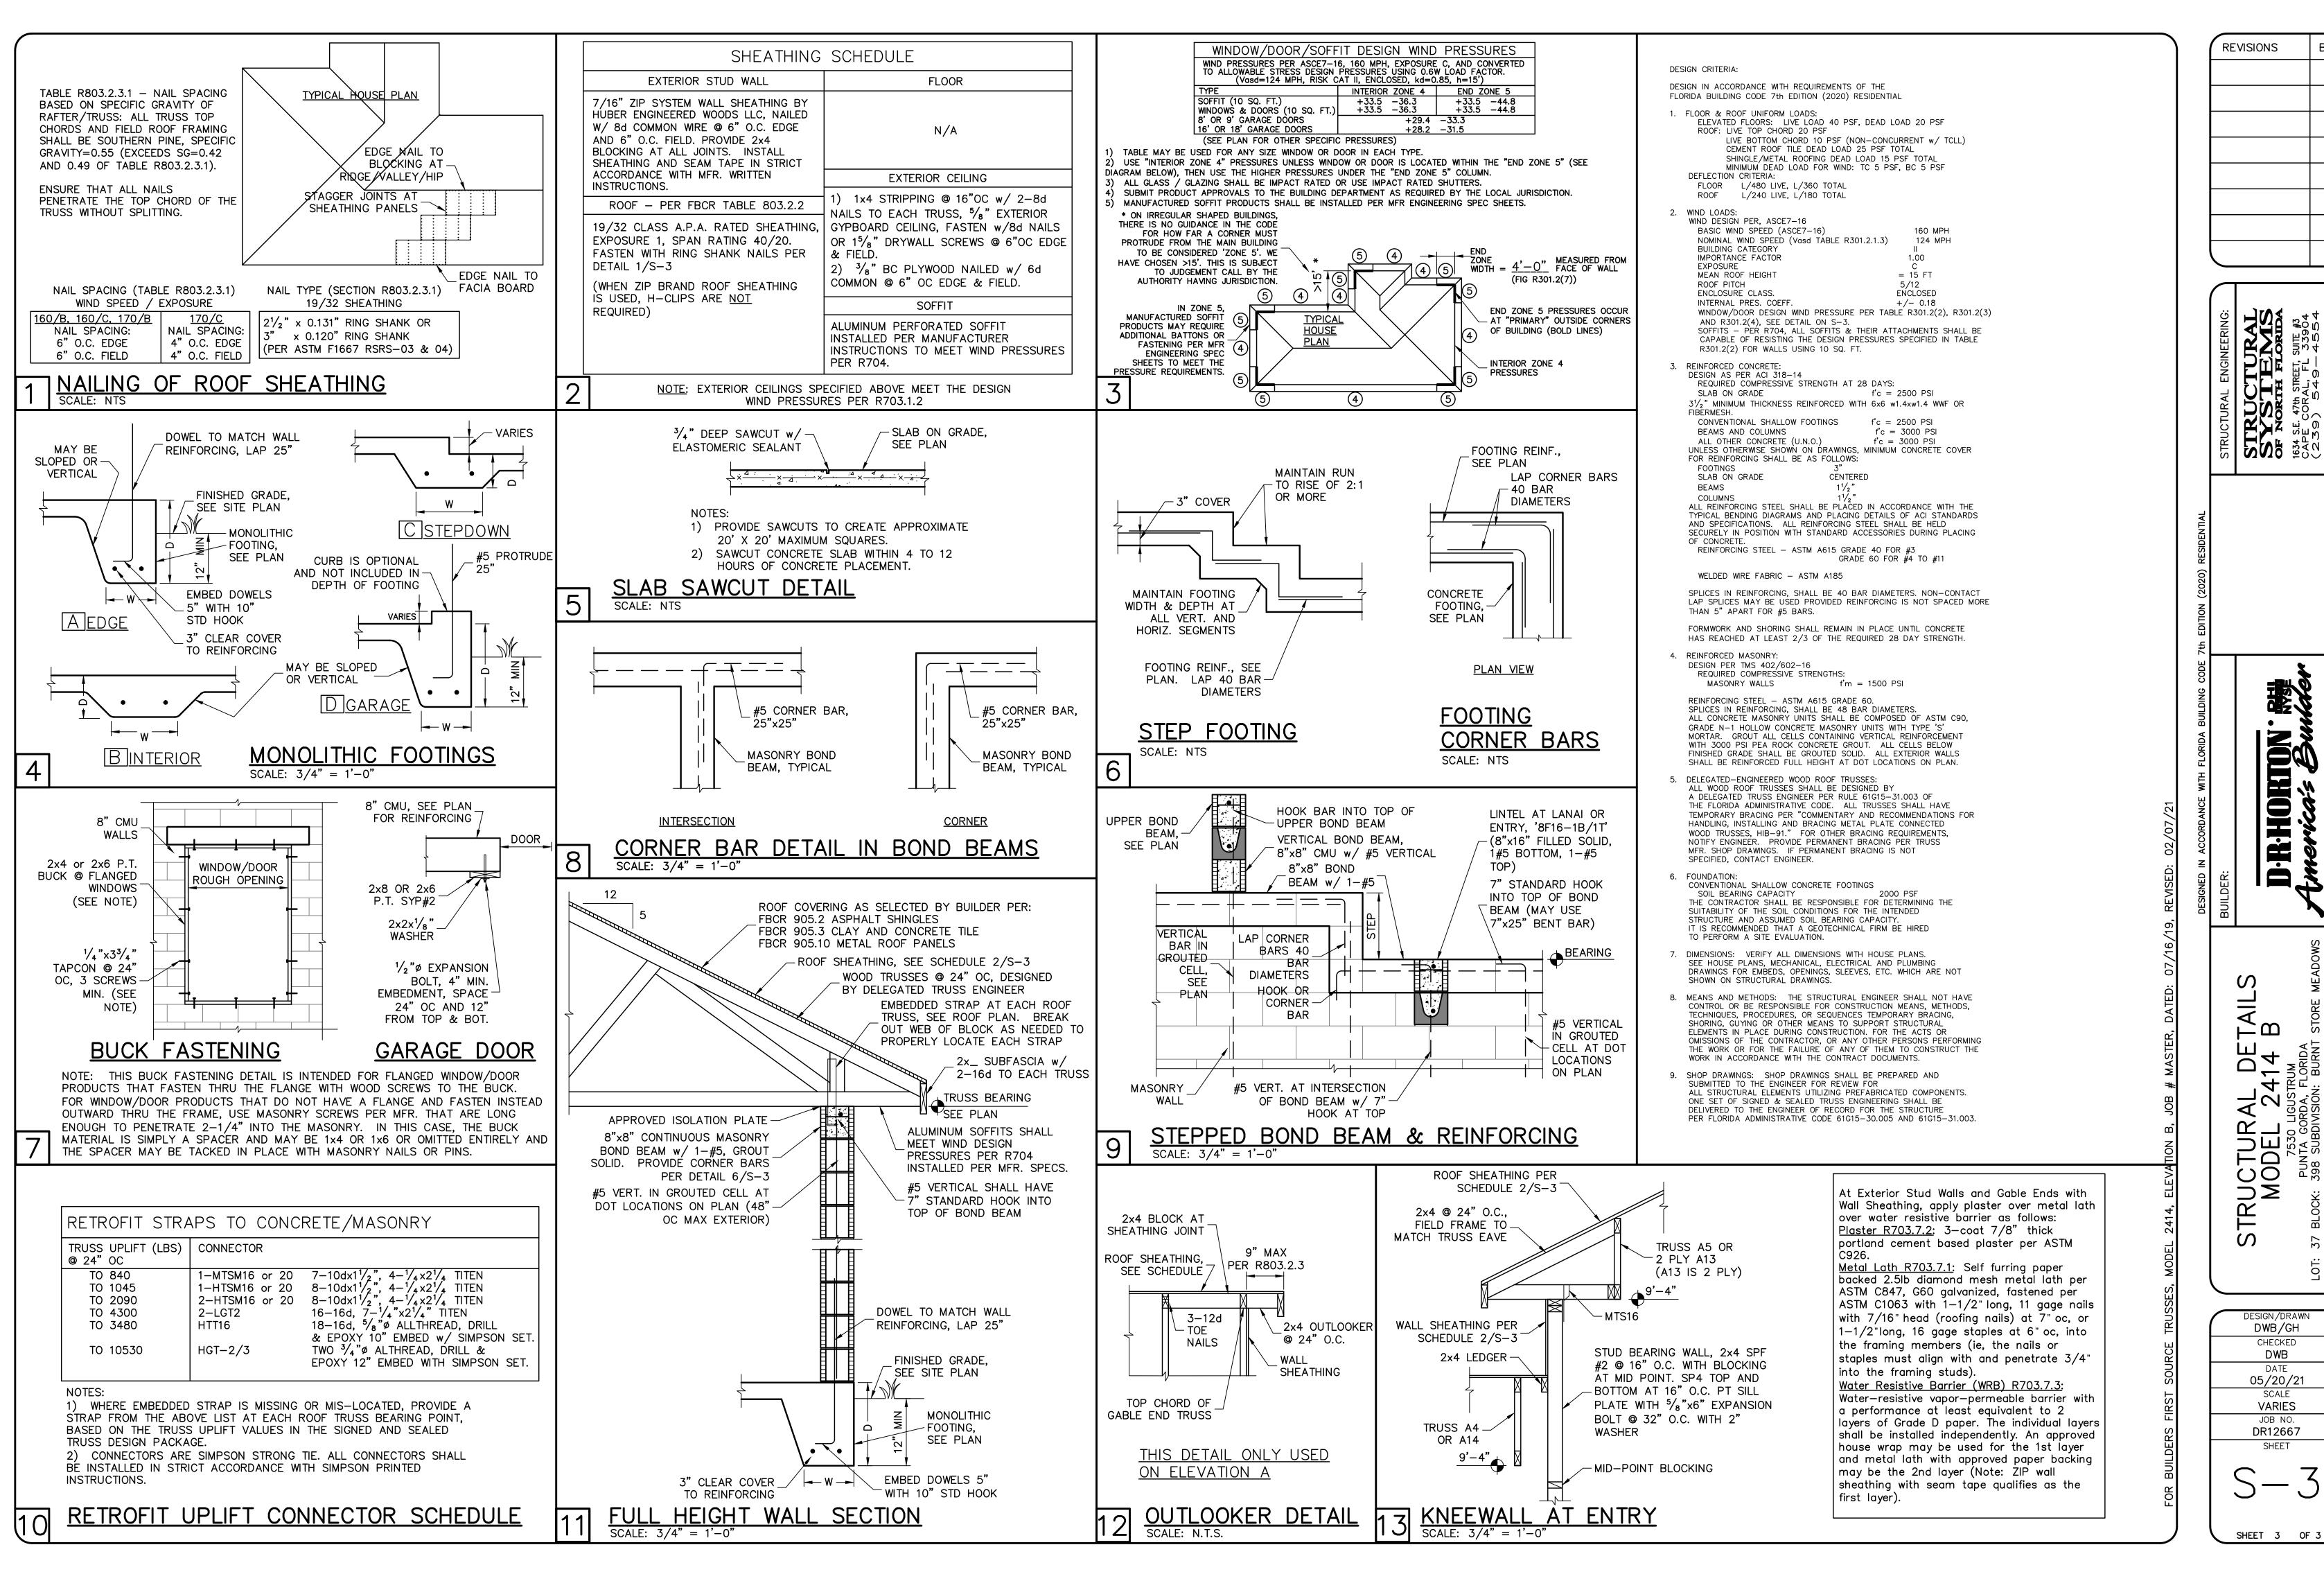

REVISIONS

IORTON -R·H

之

<u>유</u> A 2. Signary S MODEI MODEI PUNTA (

> DWB/GH CHECKED DWB 05/20/21 SCALE **VARIES** JOB NO.

> > SHEET